



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EWING COLE Federal Reserve Bank Building 100 North 6th Street Philadelphia, PA 19106 Tel: 215.923.2020 Fax: 215.574.9163			
A/E INFO			
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ACTIVITY			
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Designer	Author	Checker	
PM/DM			
BRANCH MANAGER			
CHIEF ENGR ARCH			
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NAVAL FACILITIES ENGINEERING COMMAND			
FOR COMMANDER NAVFAC			
ACTIVITY			
NAVAL FACILITIES ENGINEERING COMMAND - WASHINGTON			
MARINE CORPS BASE QUANTICO, VIRGINIA			
QUANTICO, VA			
REPLACE QUANTICO M/H SCHOOL			
LANDSCAPE ARCHITECTURAL KEY PLAN			
SCALE: 1" = 50'			
PROJECT NO.: AM000021			
CONSTR. CONTR. NO.			
NAVFAC DRAWING NO.			
SHEET ## OF ##			
L002			
DRAWN FOR REVISION: 10 MARCH 2009			

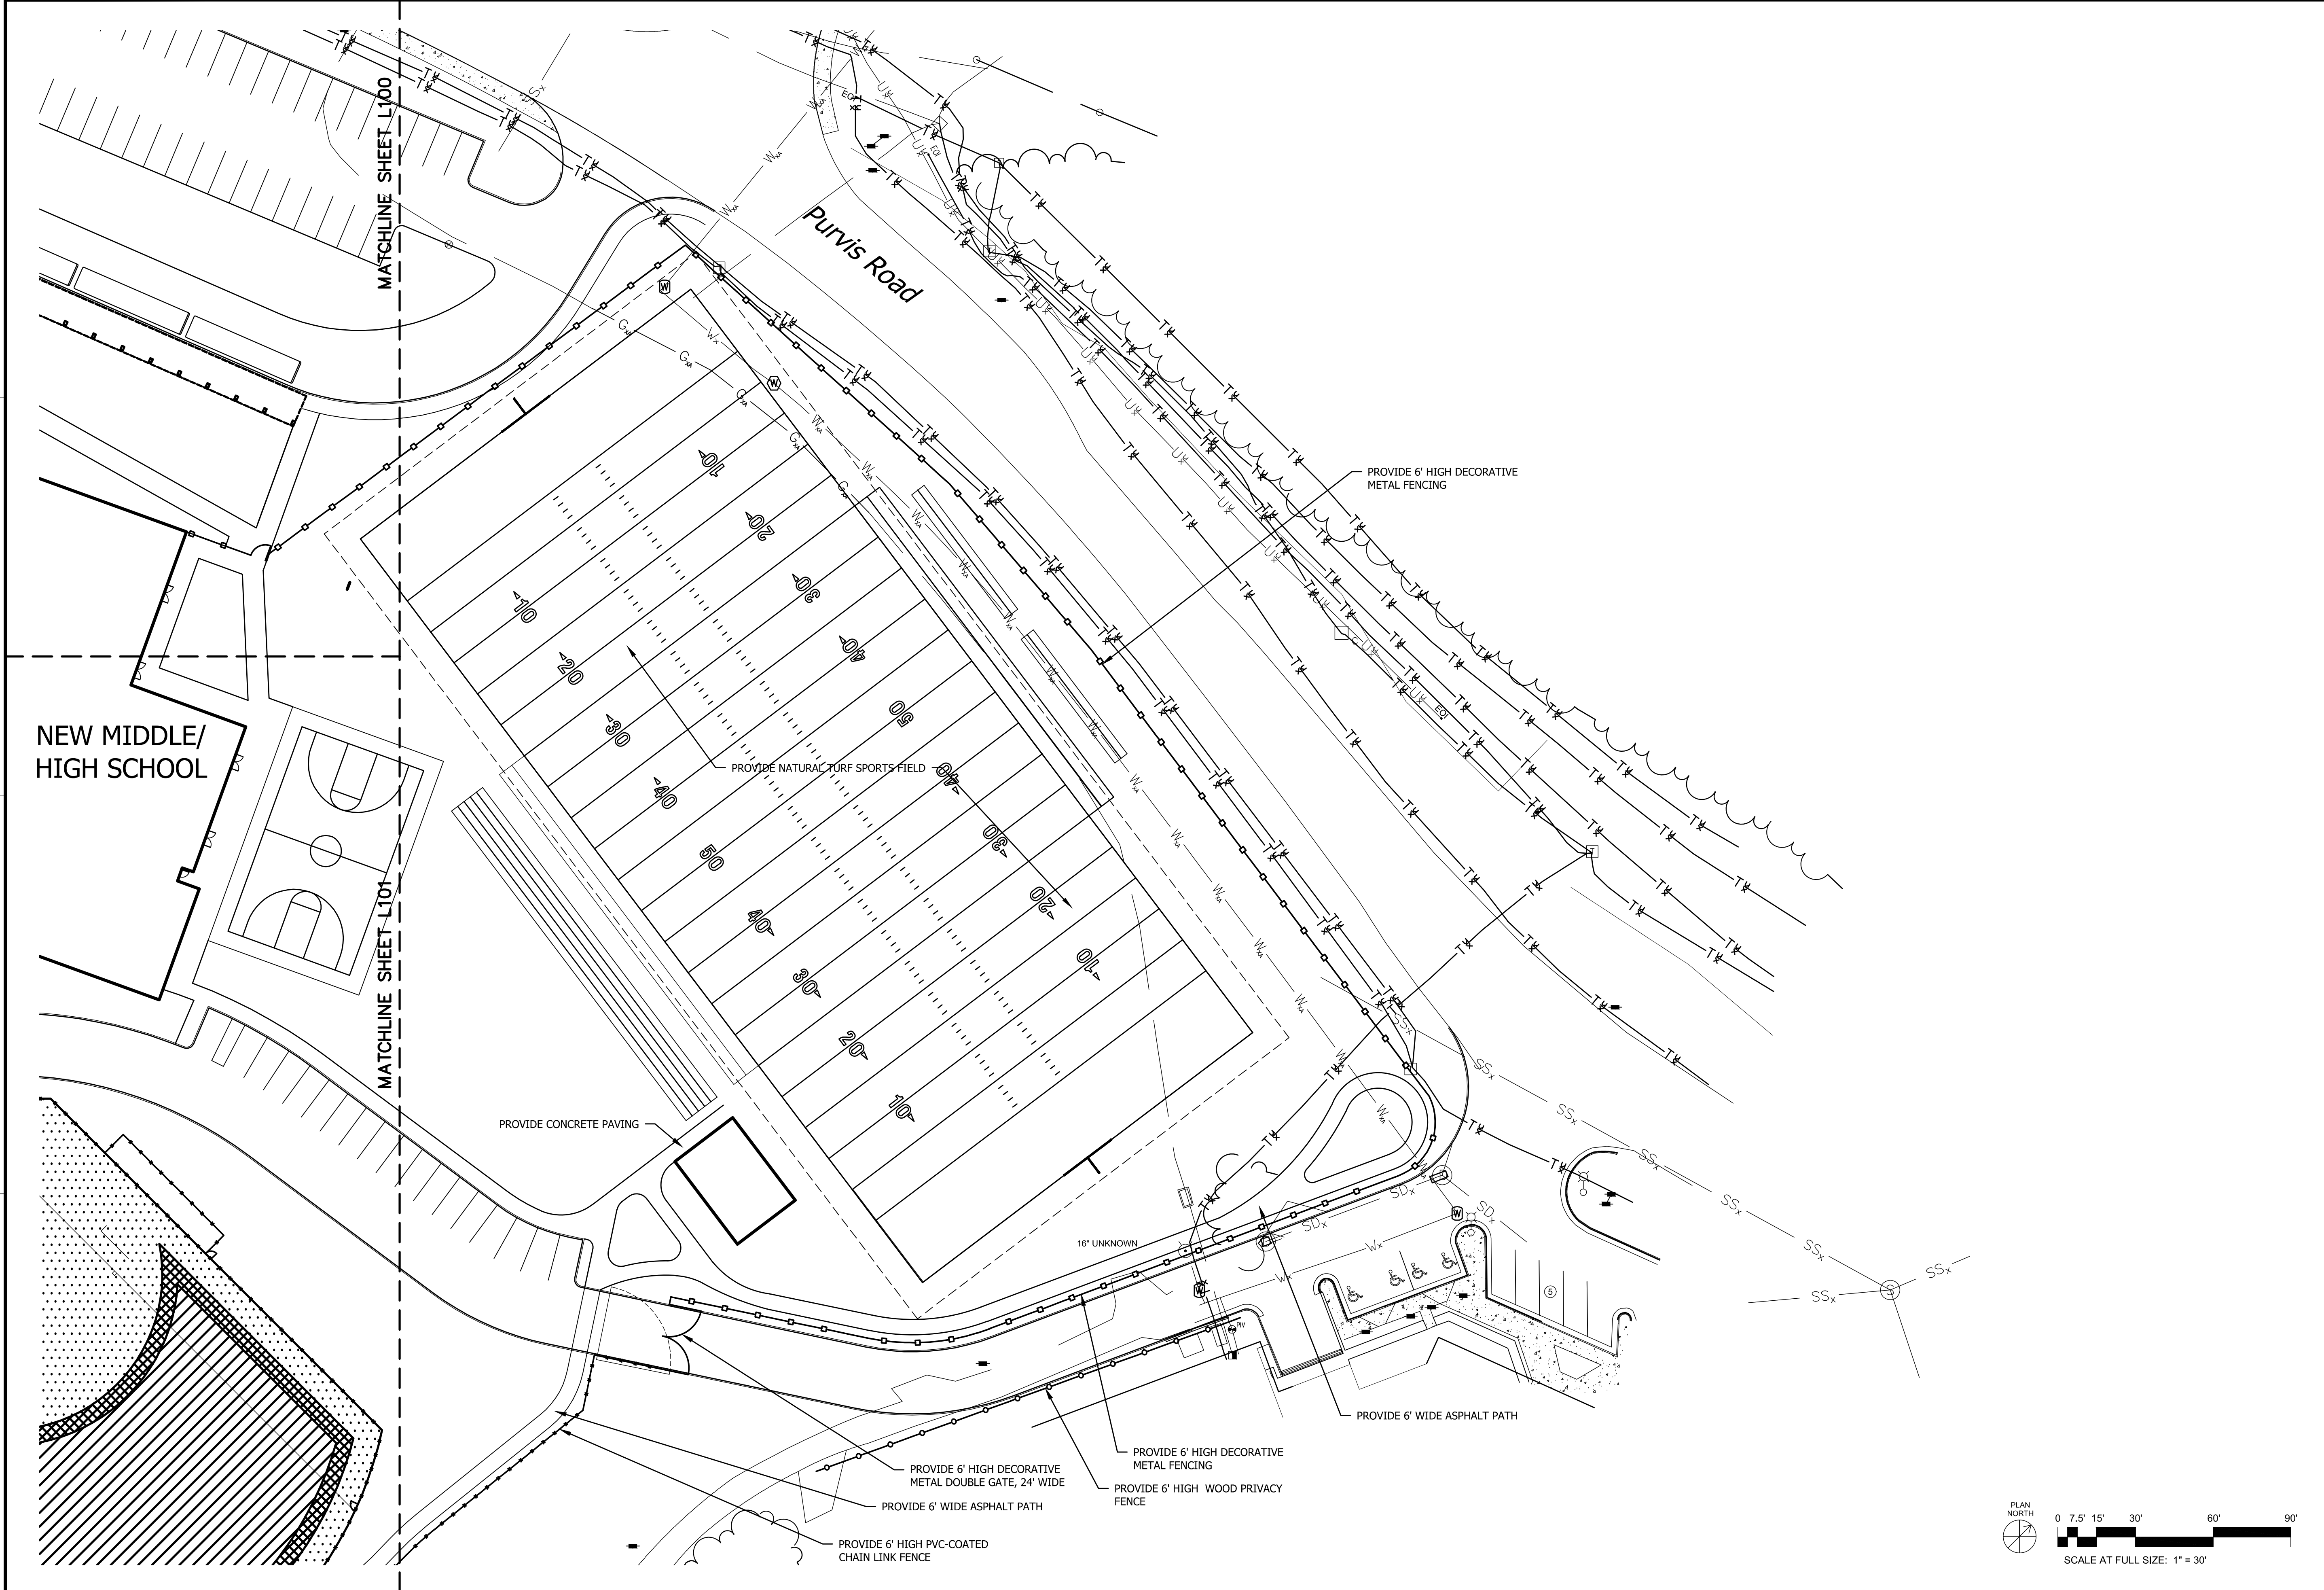

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ACTIVITY			
SATISFACTORY TO DATE			
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CHIEF ENGR ARCH			
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NAVAL FACILITIES ENGINEERING COMMAND		NAVFAC ENGINEERING COMMAND	
DEPARTMENT OF THE NAVY		NAVFAC ENGINEERING COMMAND - WASHINGTON	
DDEA		MARINE CORPS BASE QUANTICO, VIRGINIA	
MARINE CORPS BASE QUANTICO		QUANTICO, VA	
REPLACE QUANTICO M/H SCHOOL		LANDSCAPE ARCHITECTURAL SITE PLAN AREA C	
SCALE: 1" = 30'		PROJECT NO.: AM000021	
CONSTR. CONTR. NO.		NAVFAC DRAWING NO.	
SHEET ## OF		#####	
L102			
DRAWING REVISION:		10 MARCH 2009	

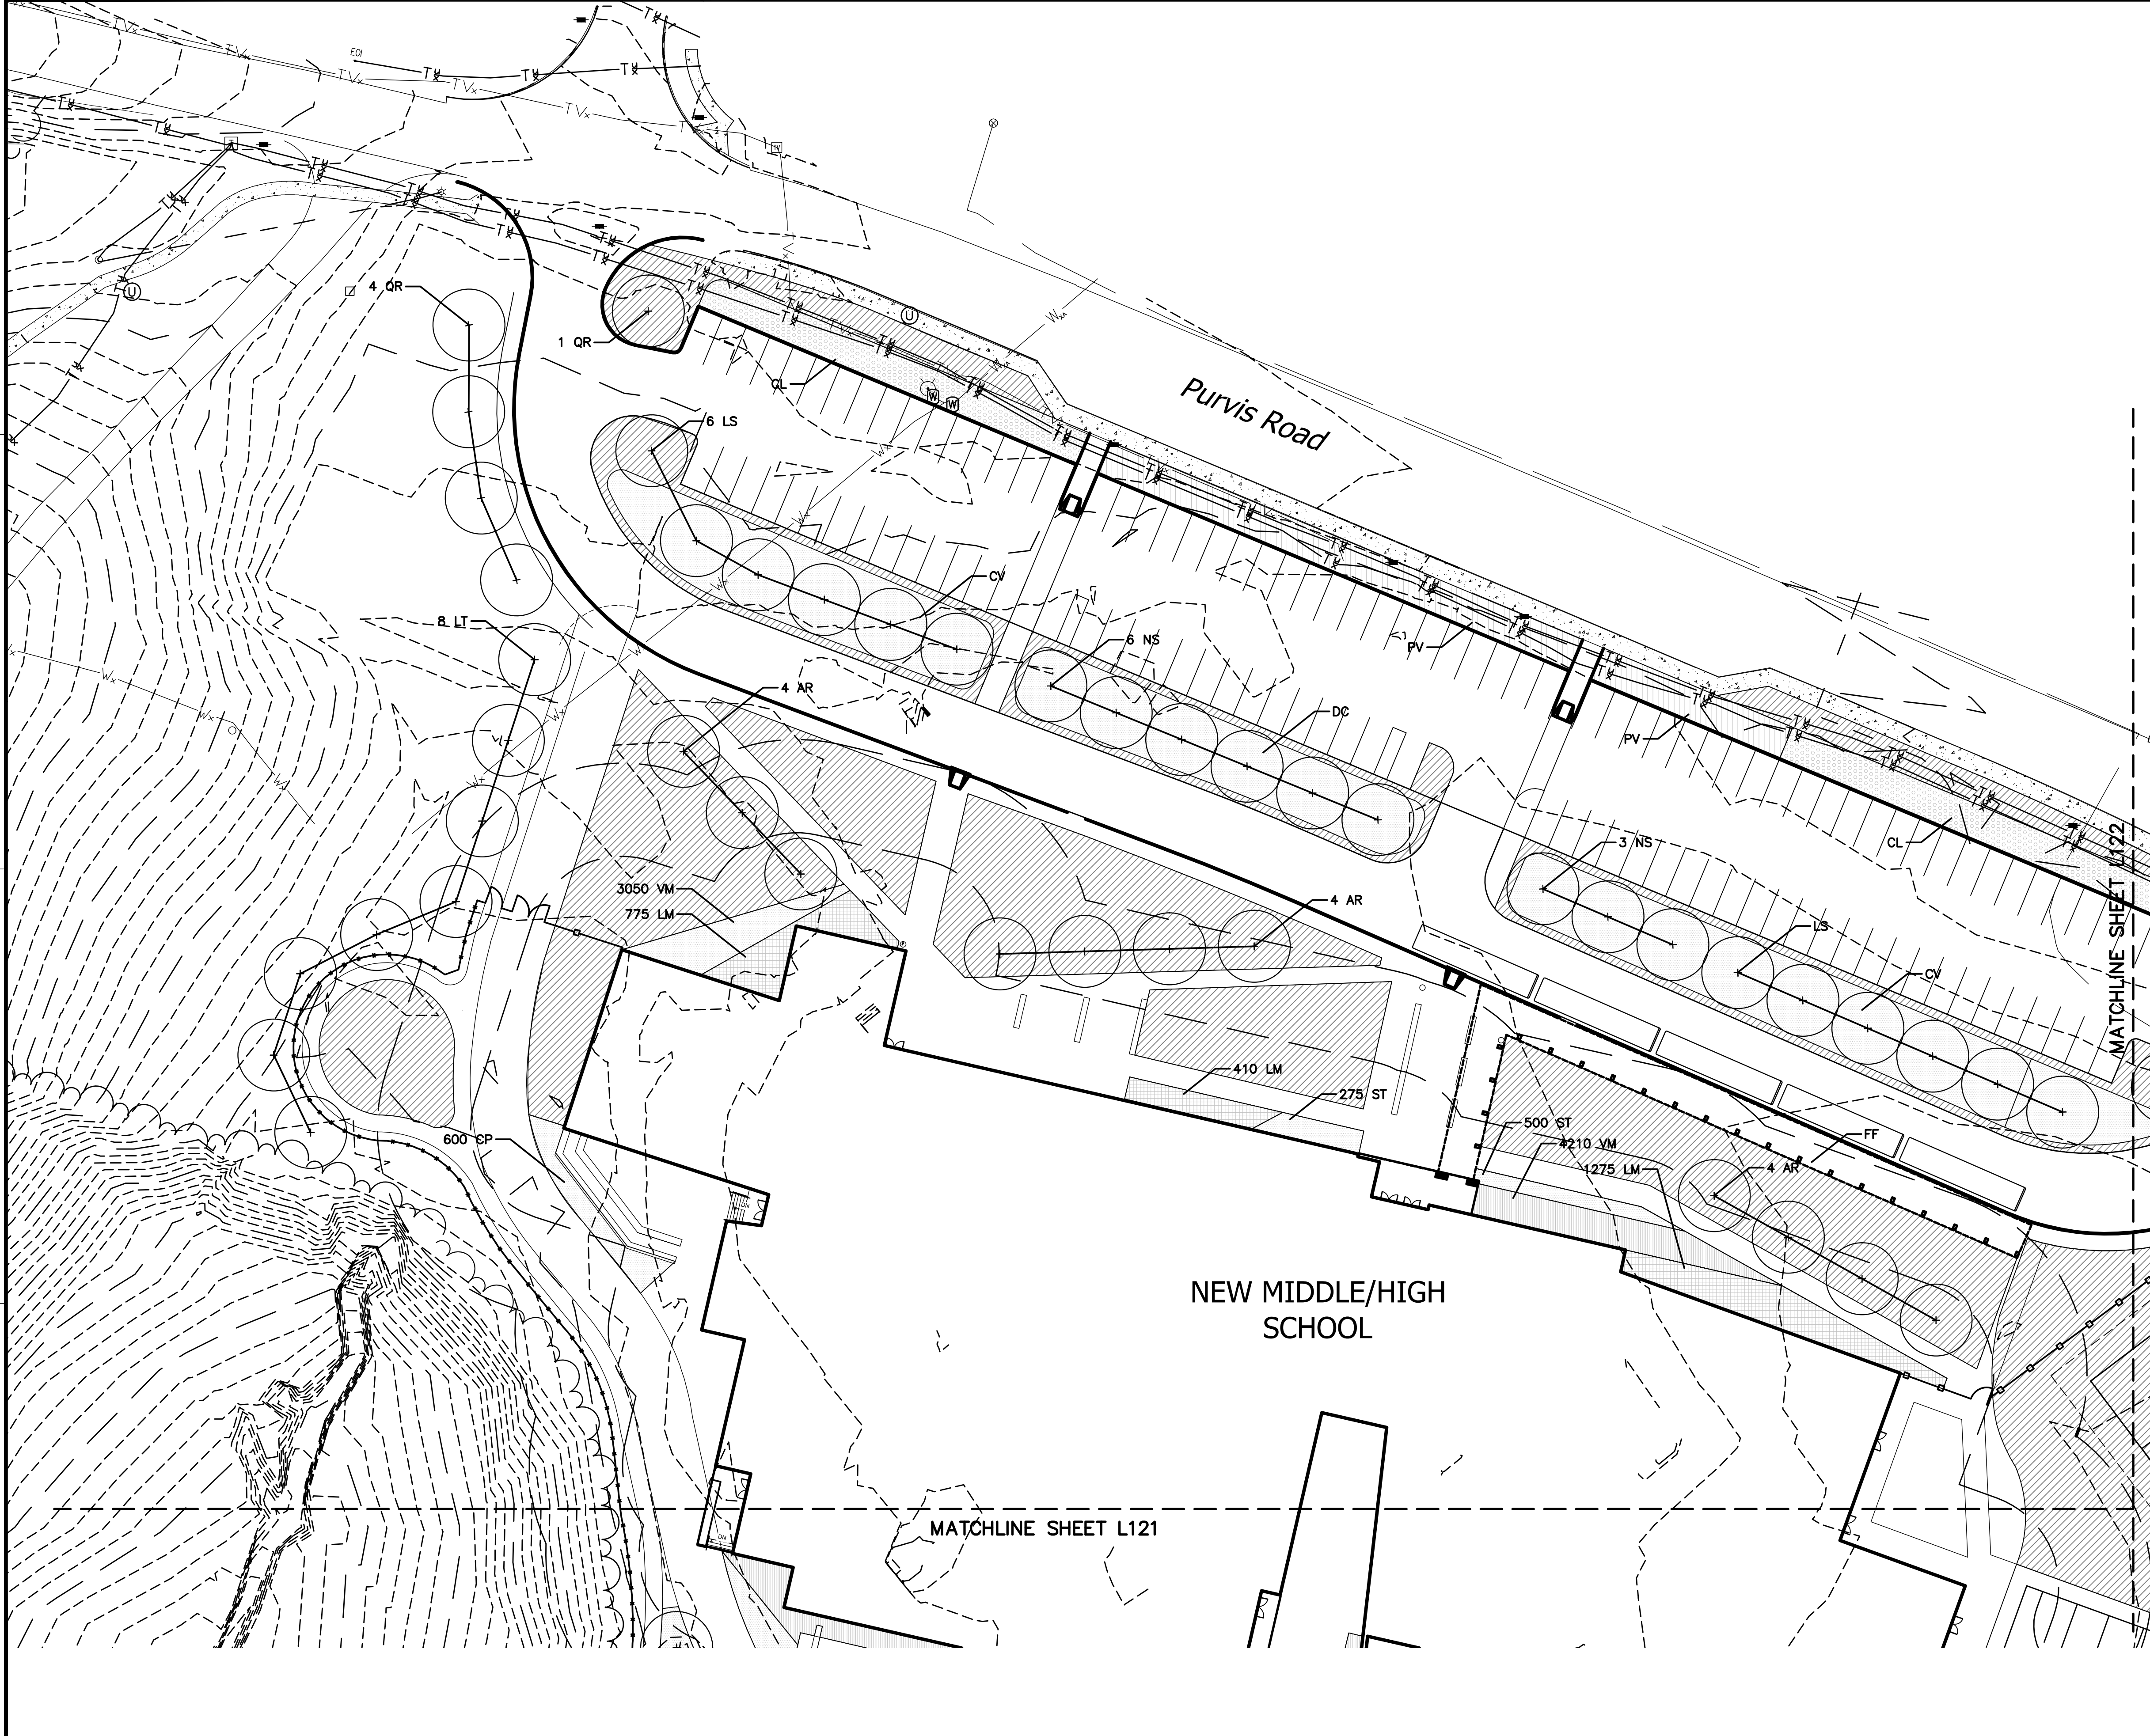

LEGEND

PROPOSED DECIDUOUS SHADE TREE

PROPOSED DECIDUOUS MULTI-STEM TREE

PROPOSED EVERGREEN TREE

PROPOSED SHRUB

PROPOSED HERBACEOUS PERENNIAL

PROPOSED HERBACEOUS PERENNIAL

PROPOSED HERBACEOUS PERENNIAL


PROPOSED TURF

PLAN NORTH

0 7.5' 15' 30' 60' 90'


SCALE AT FULL SIZE: 1" = 30'

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SATISFACTORY TO DATE	
Designer	Author
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BRANCH MANAGER	
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NAVAL FACILITIES ENGINEERING COMMAND	
NAVAL FACILITIES ENGINEERING COMMAND - WASHINGTON	
MARINE CORPS BASE QUANTICO, VIRGINIA	
QUANTICO, VA	
REPLACE QUANTICO M/H SCHOOL	
LANDSCAPE PLANTING PLAN AREA A	
SCALE: 1" = 30'	
PROJECT NO.: AM0000021	
CONSTR. CONTR. NO.	
NAVFAC DRAWING NO.	
SHEET ## OF	
L120	
DRAWN/FORM REVISION: 10 MARCH 2009	

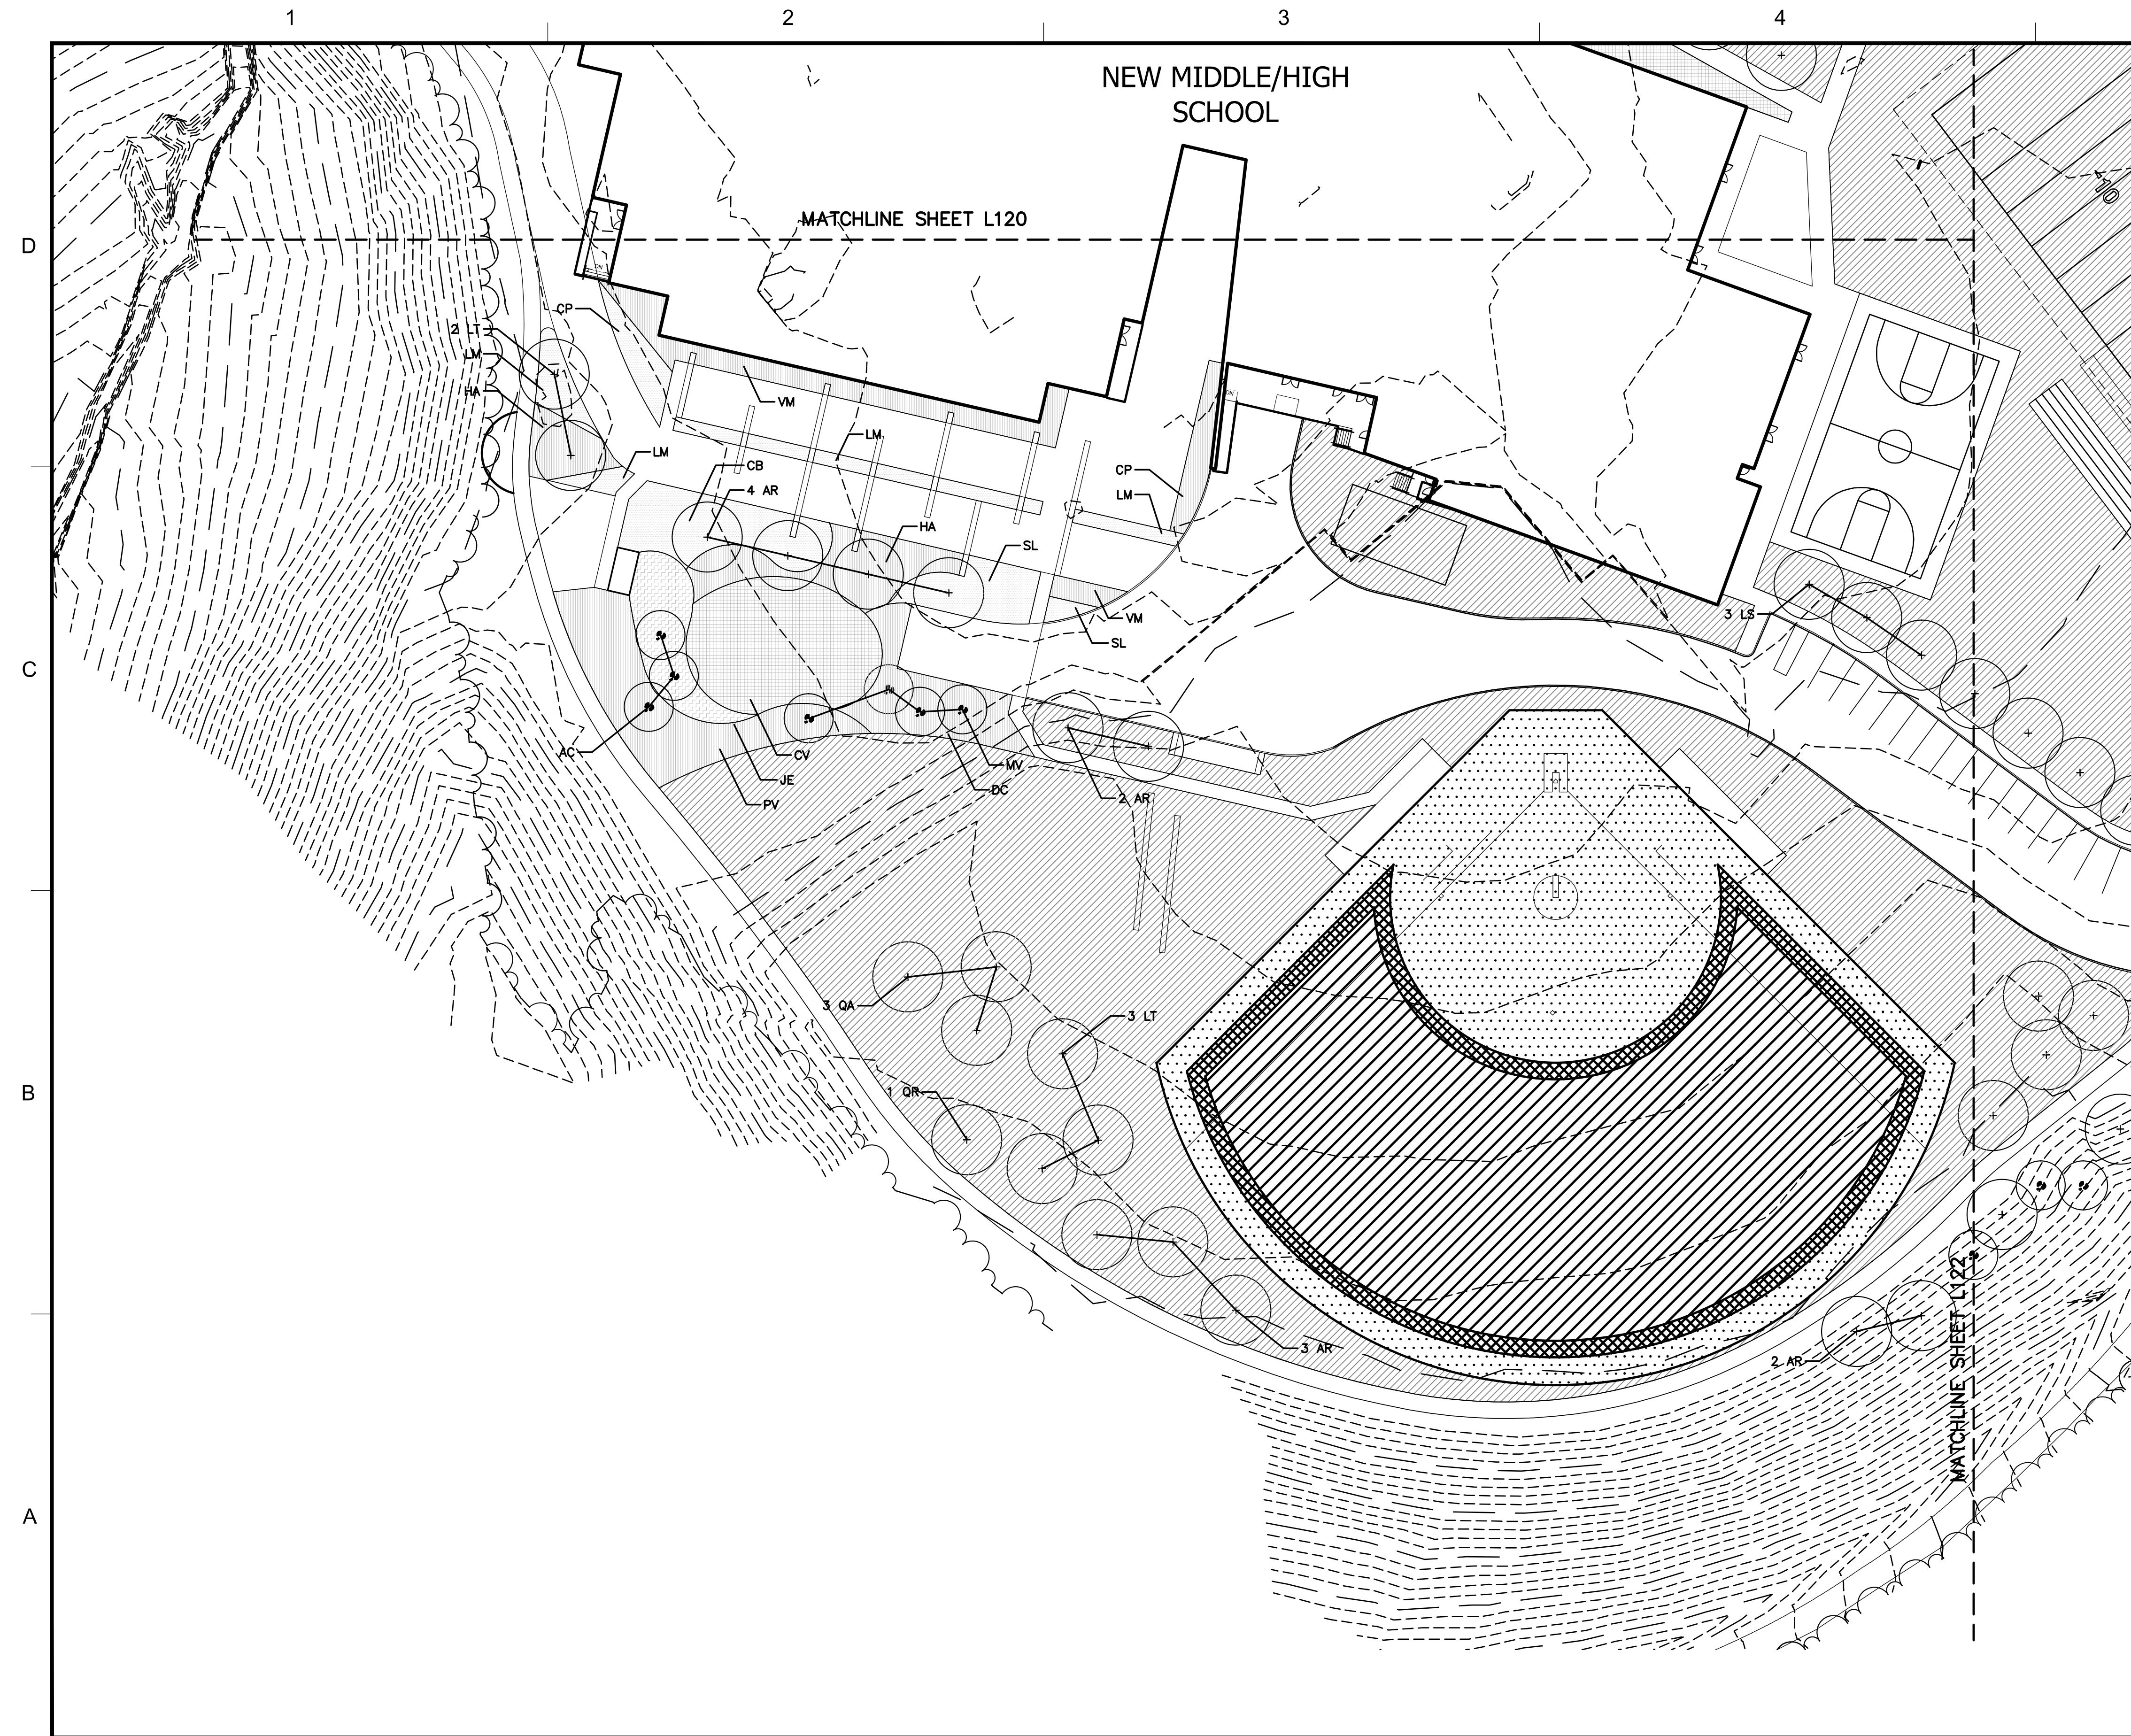

LEGEND

- PROPOSED DECIDUOUS SHADE TREE
- PROPOSED DECIDUOUS MULTI-STEM TREE
- PROPOSED EVERGREEN TREE
- PROPOSED SHRUB
- PROPOSED HERBACEOUS PERENNIAL
- PROPOSED HERBACEOUS PERENNIAL
- PROPOSED HERBACEOUS PERENNIAL
- PROPOSED TURF

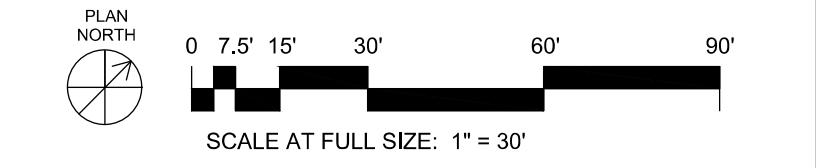



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DESIGNER	AUTHOR	CHECKER	
PROJECT NO. AM000021			
CONSTR. CONTR. NO.			
NAVFAC DRAWING NO. #####			
SHEET # OF			
L121			

DEPARTMENT OF THE NAVY
NAVAL FACILITIES ENGINEERING COMMAND - WASHINGTON
MARINE CORPS BASE QUANTICO
REPLACE QUANTICO M/H SCHOOL

QUANTICO, VA

LANDSCAPE PLANTING PLAN AREA A


15 MARCH 2009

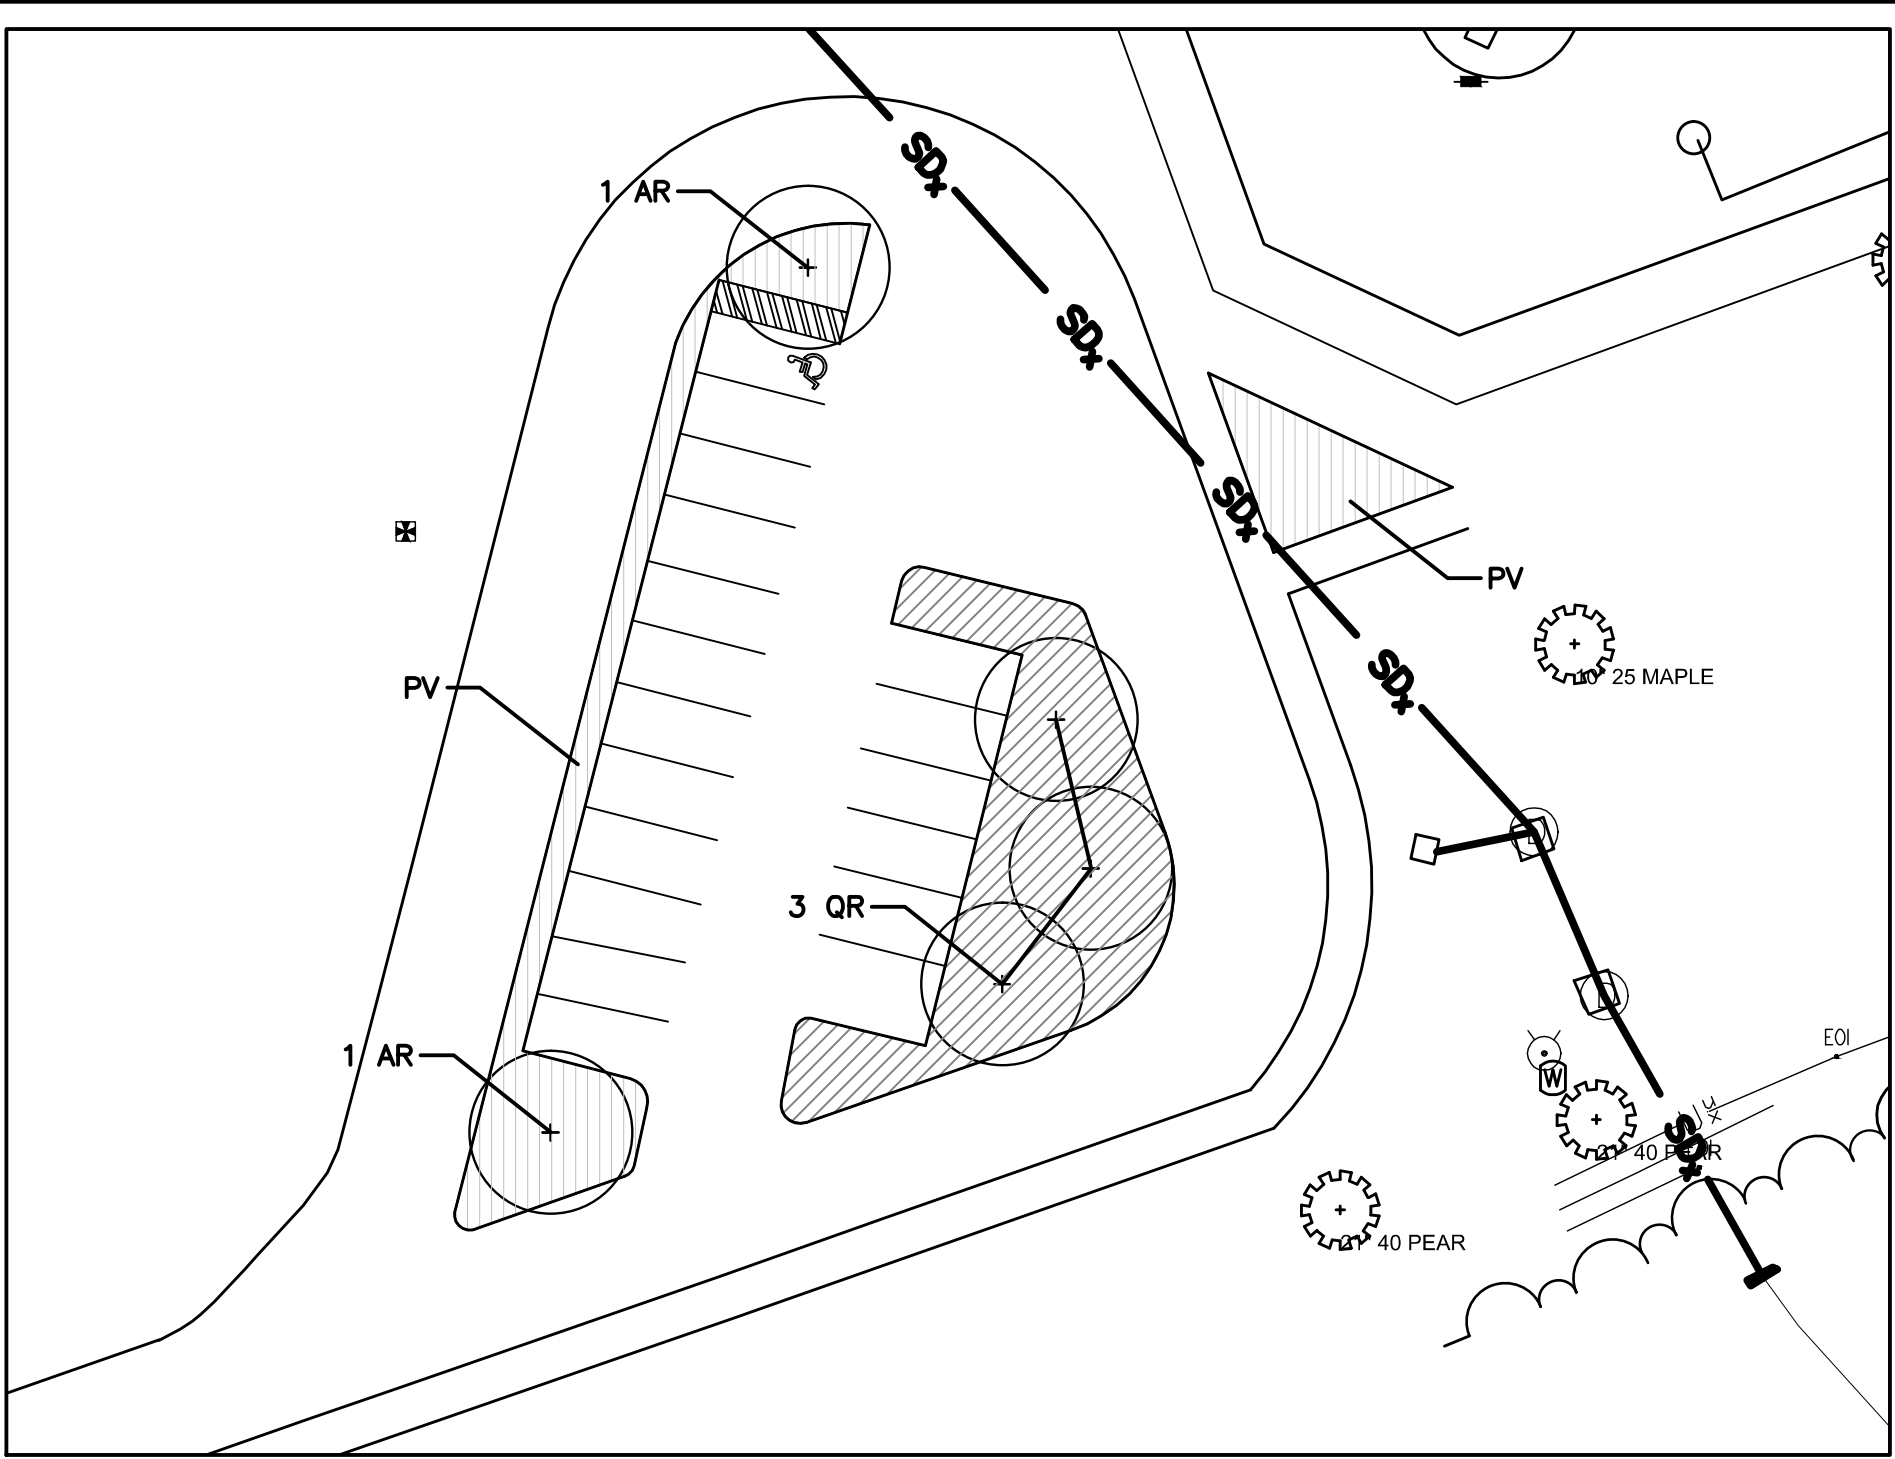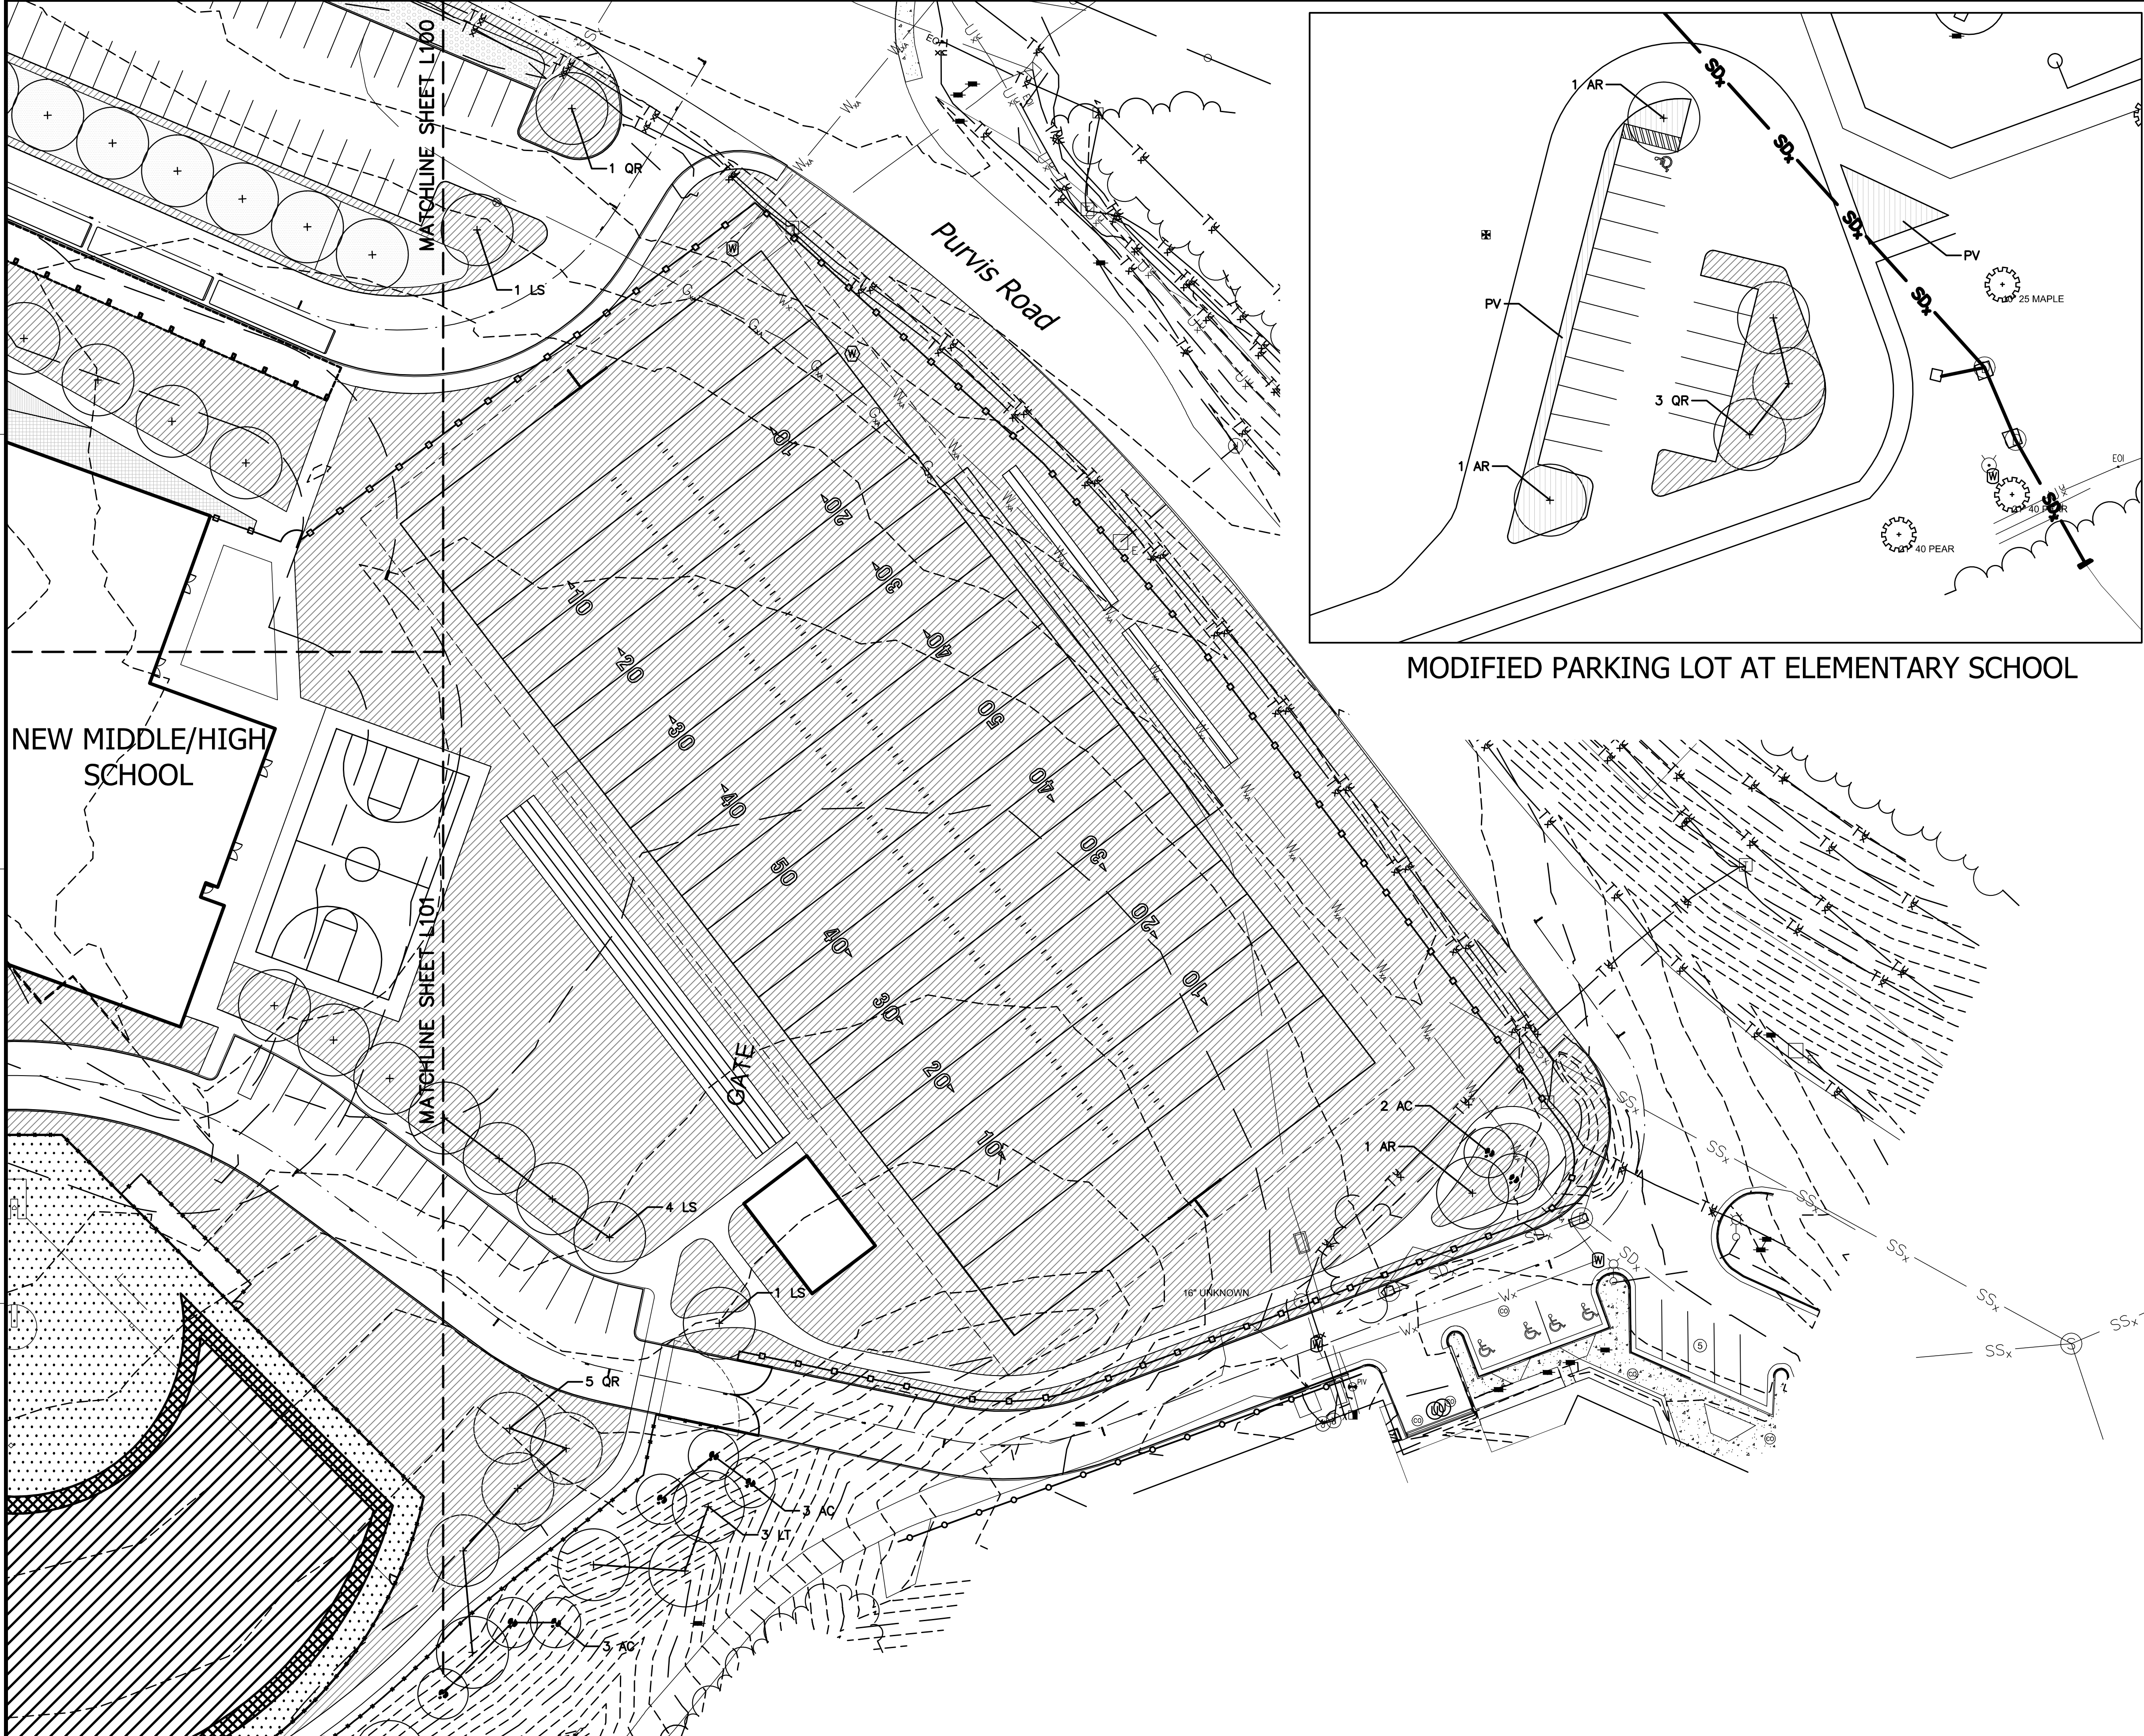

MODIFIED PARKING LOT AT ELEMENTARY SCHOOL



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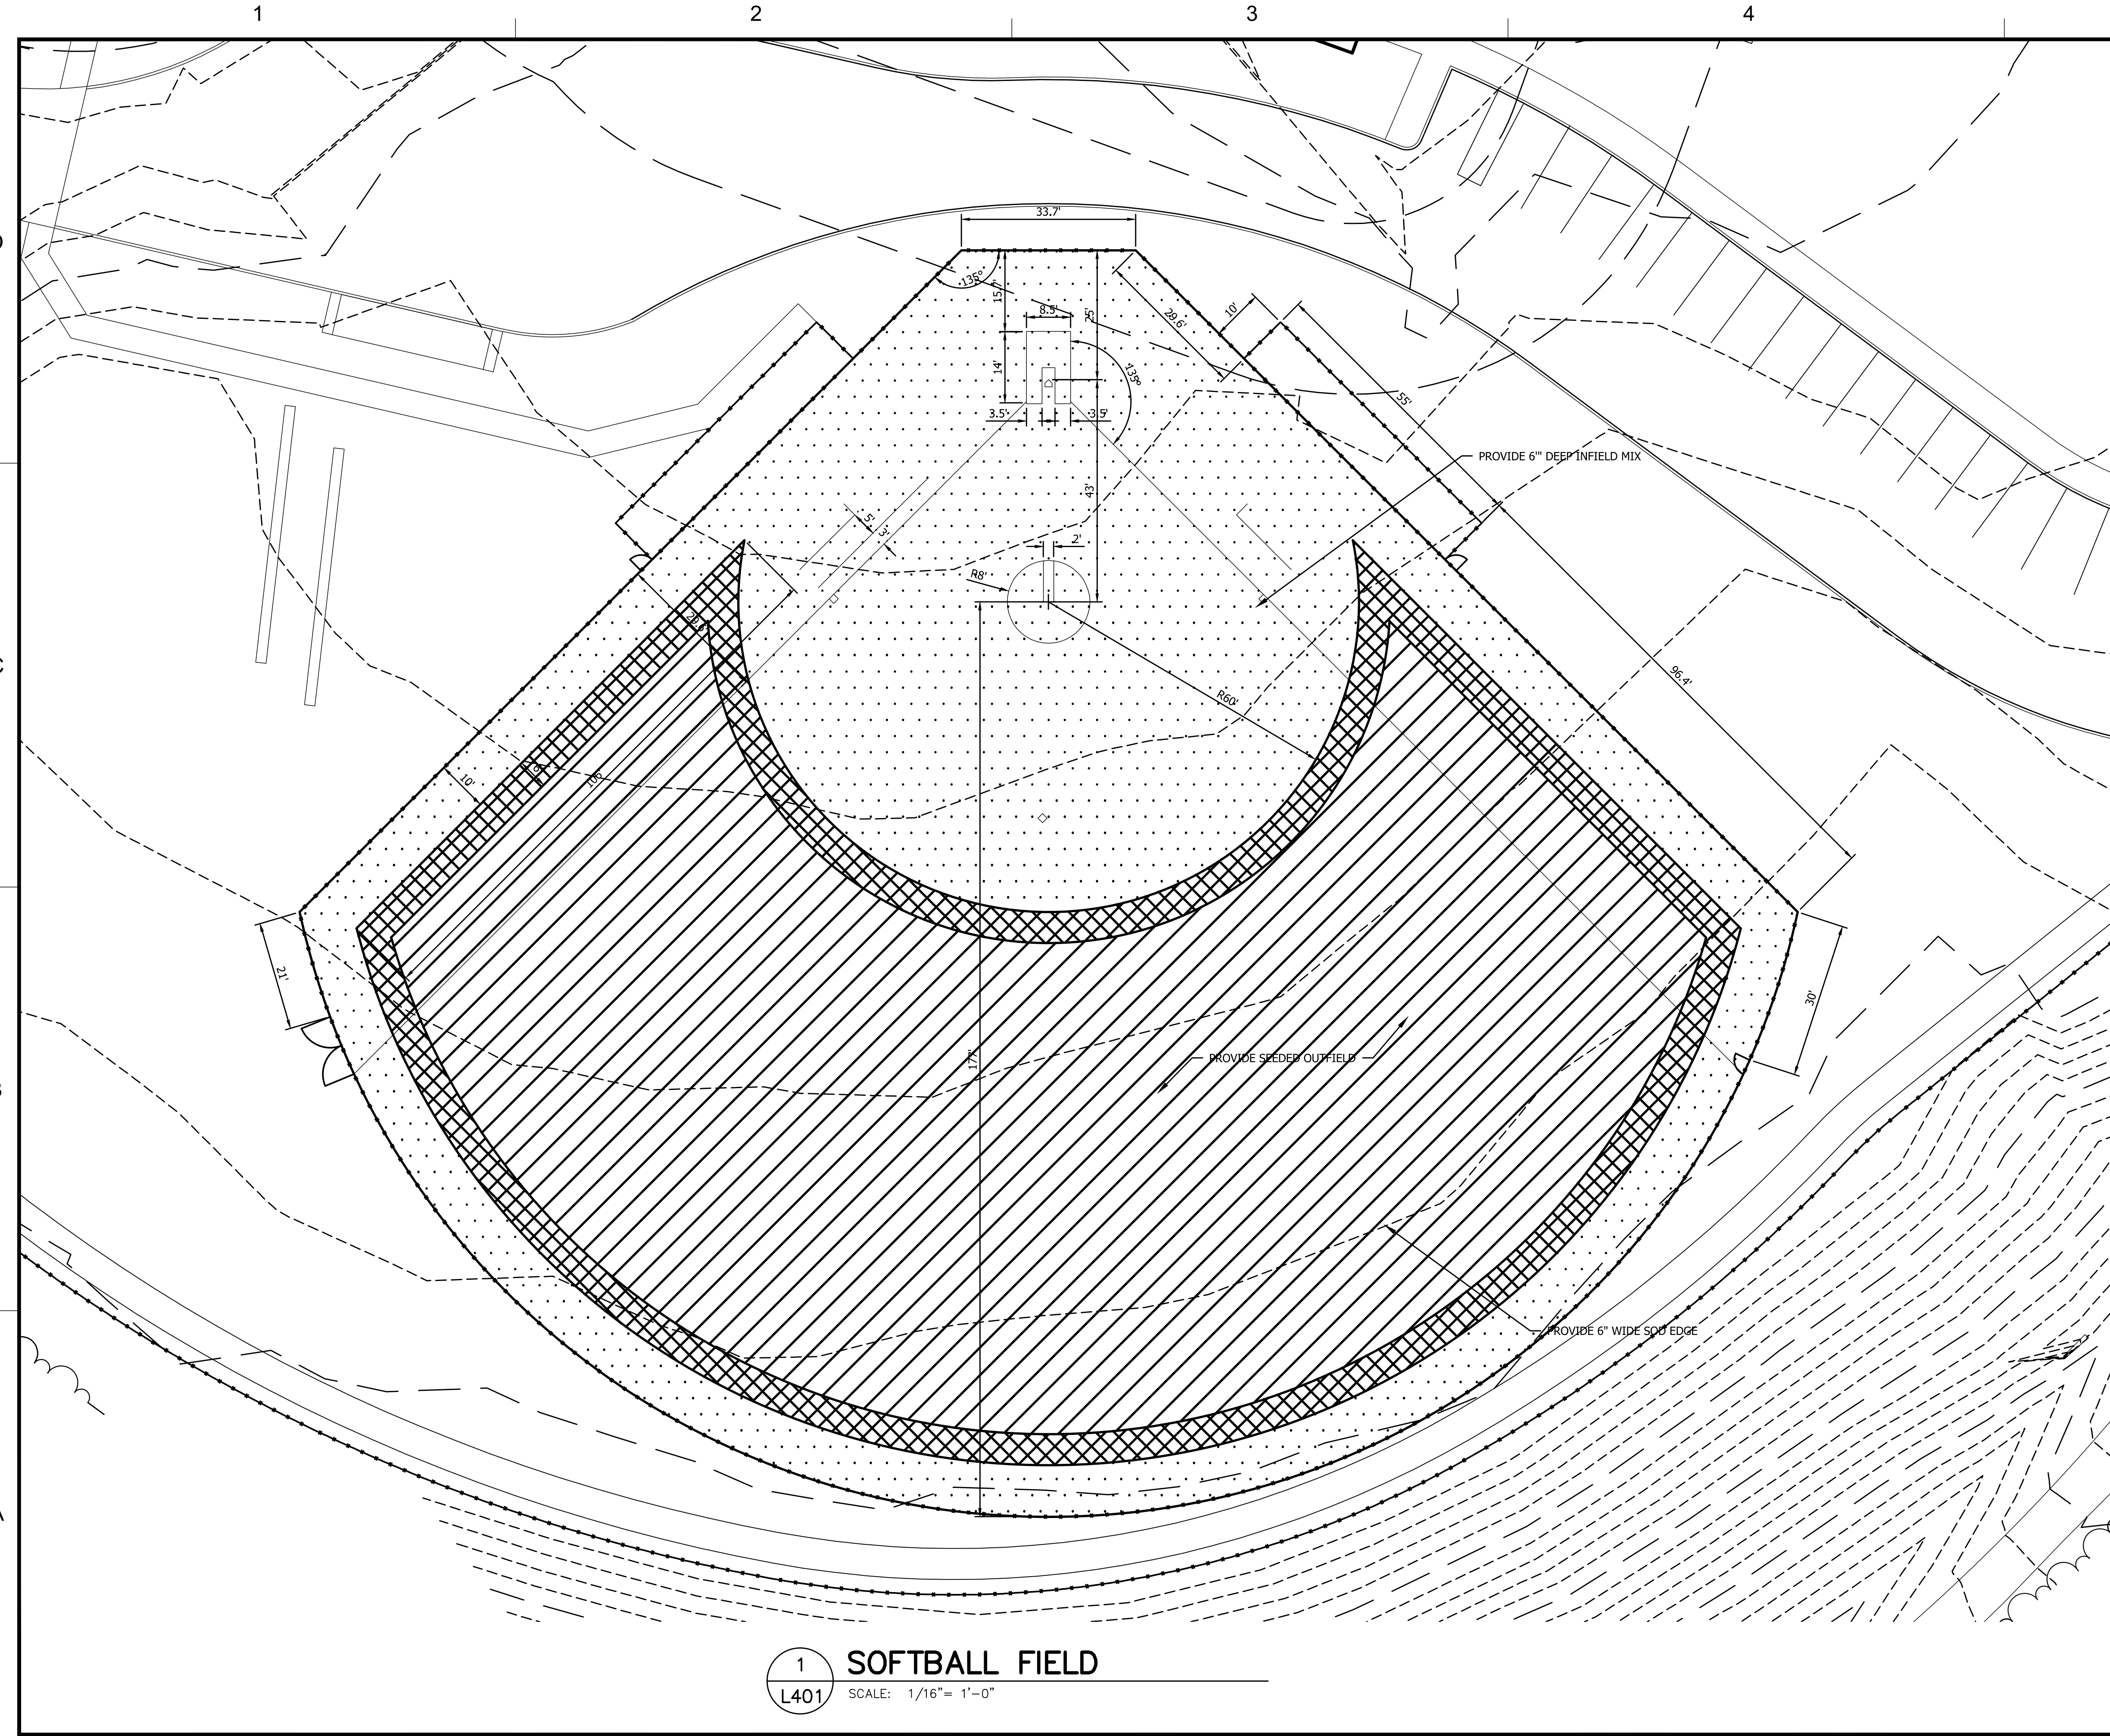
- PROPOSED DECIDUOUS SHADE TREE
- PROPOSED DECIDUOUS MULTI-STEM TREE
- PROPOSED EVERGREEN TREE
- PROPOSED SHRUB
- PROPOSED HERBACEOUS PERENNIAL
- PROPOSED HERBACEOUS PERENNIAL
- PROPOSED HERBACEOUS PERENNIAL
- PROPOSED TURF

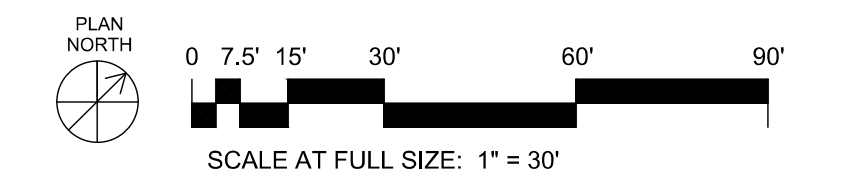

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BRANCH MANAGER			
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NAVAL FACILITIES ENGINEERING COMMAND		QUANTICO, VA	
NAVAL FACILITIES ENGINEERING COMMAND - WASHINGTON		QUANTICO, VA	
MARINE CORPS BASE QUANTICO, VIRGINIA		QUANTICO, VA	
REPLACE QUANTICO M/H SCHOOL		LANDSCAPE PLANTING PLAN AREA A	
SCALE: 1" = 30'		PROJECT NO.: AM000021	
CONSTR. CONTR. NO.		NAVFAC DRAWING NO.	
SHEET ## OF		DRAWING REVISION	
L122		10 MARCH 2009	

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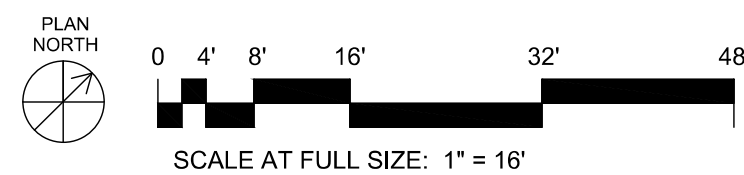
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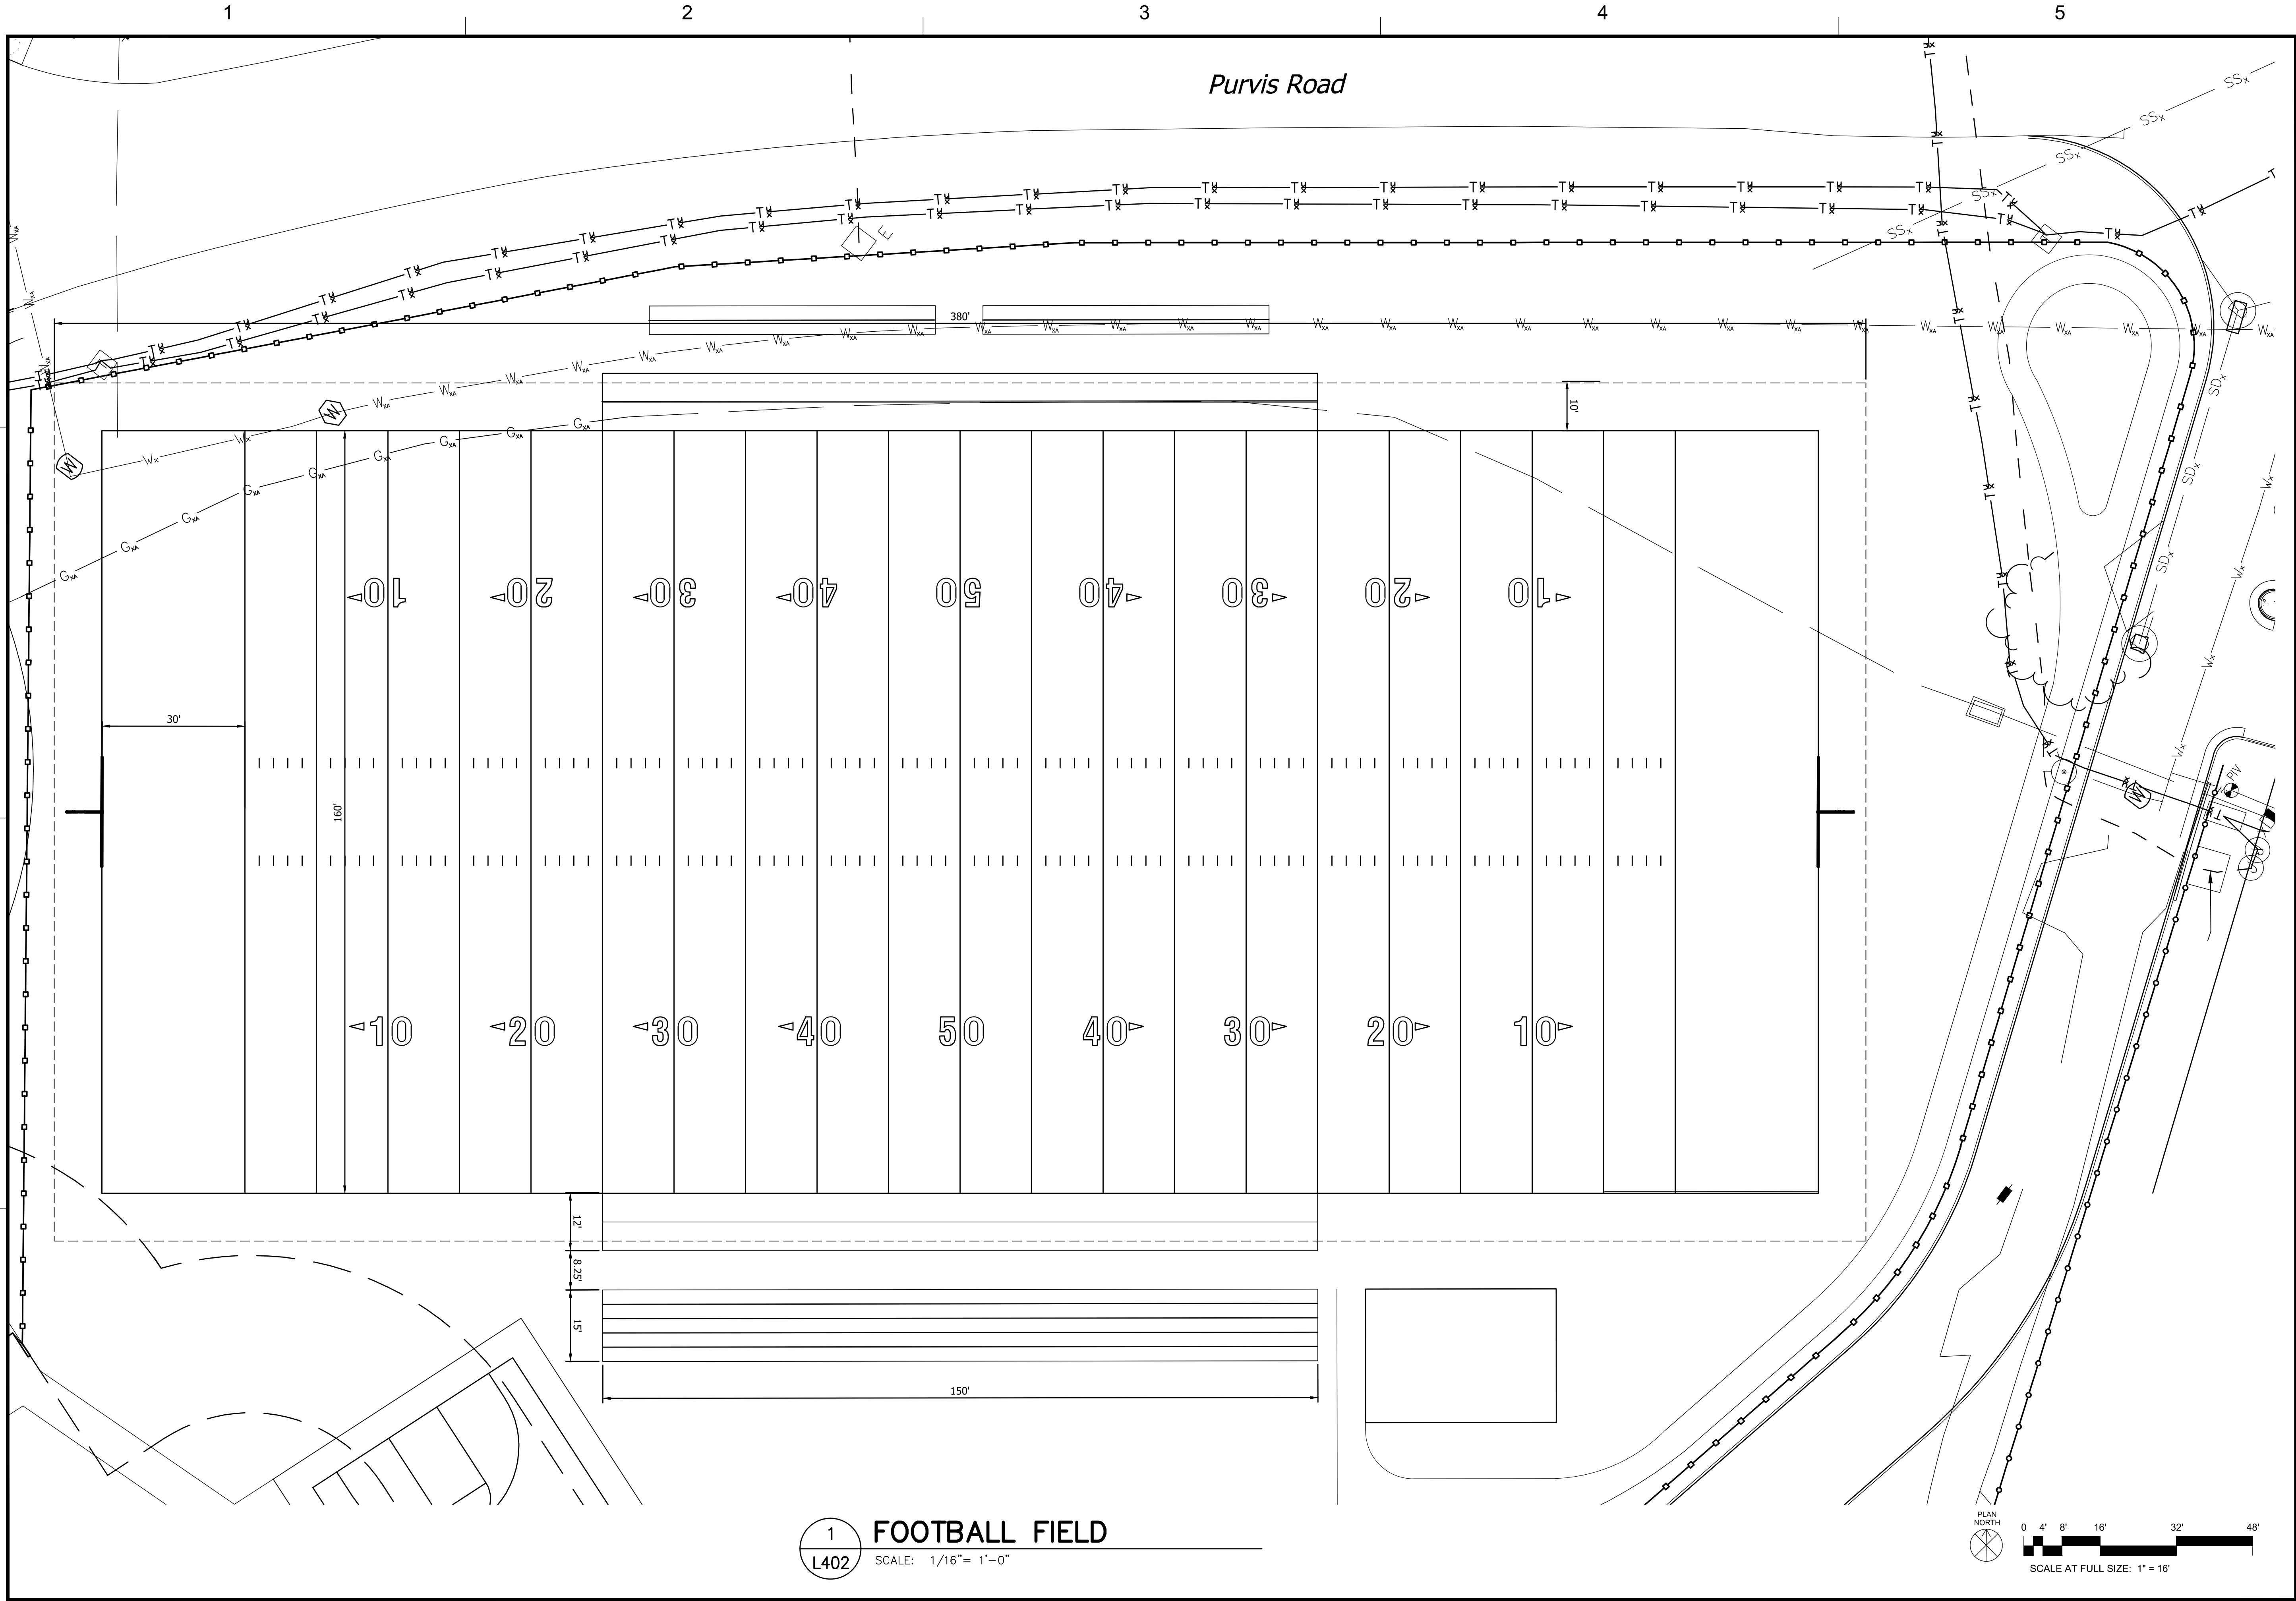
1
L401

SOFTBALL FIELD

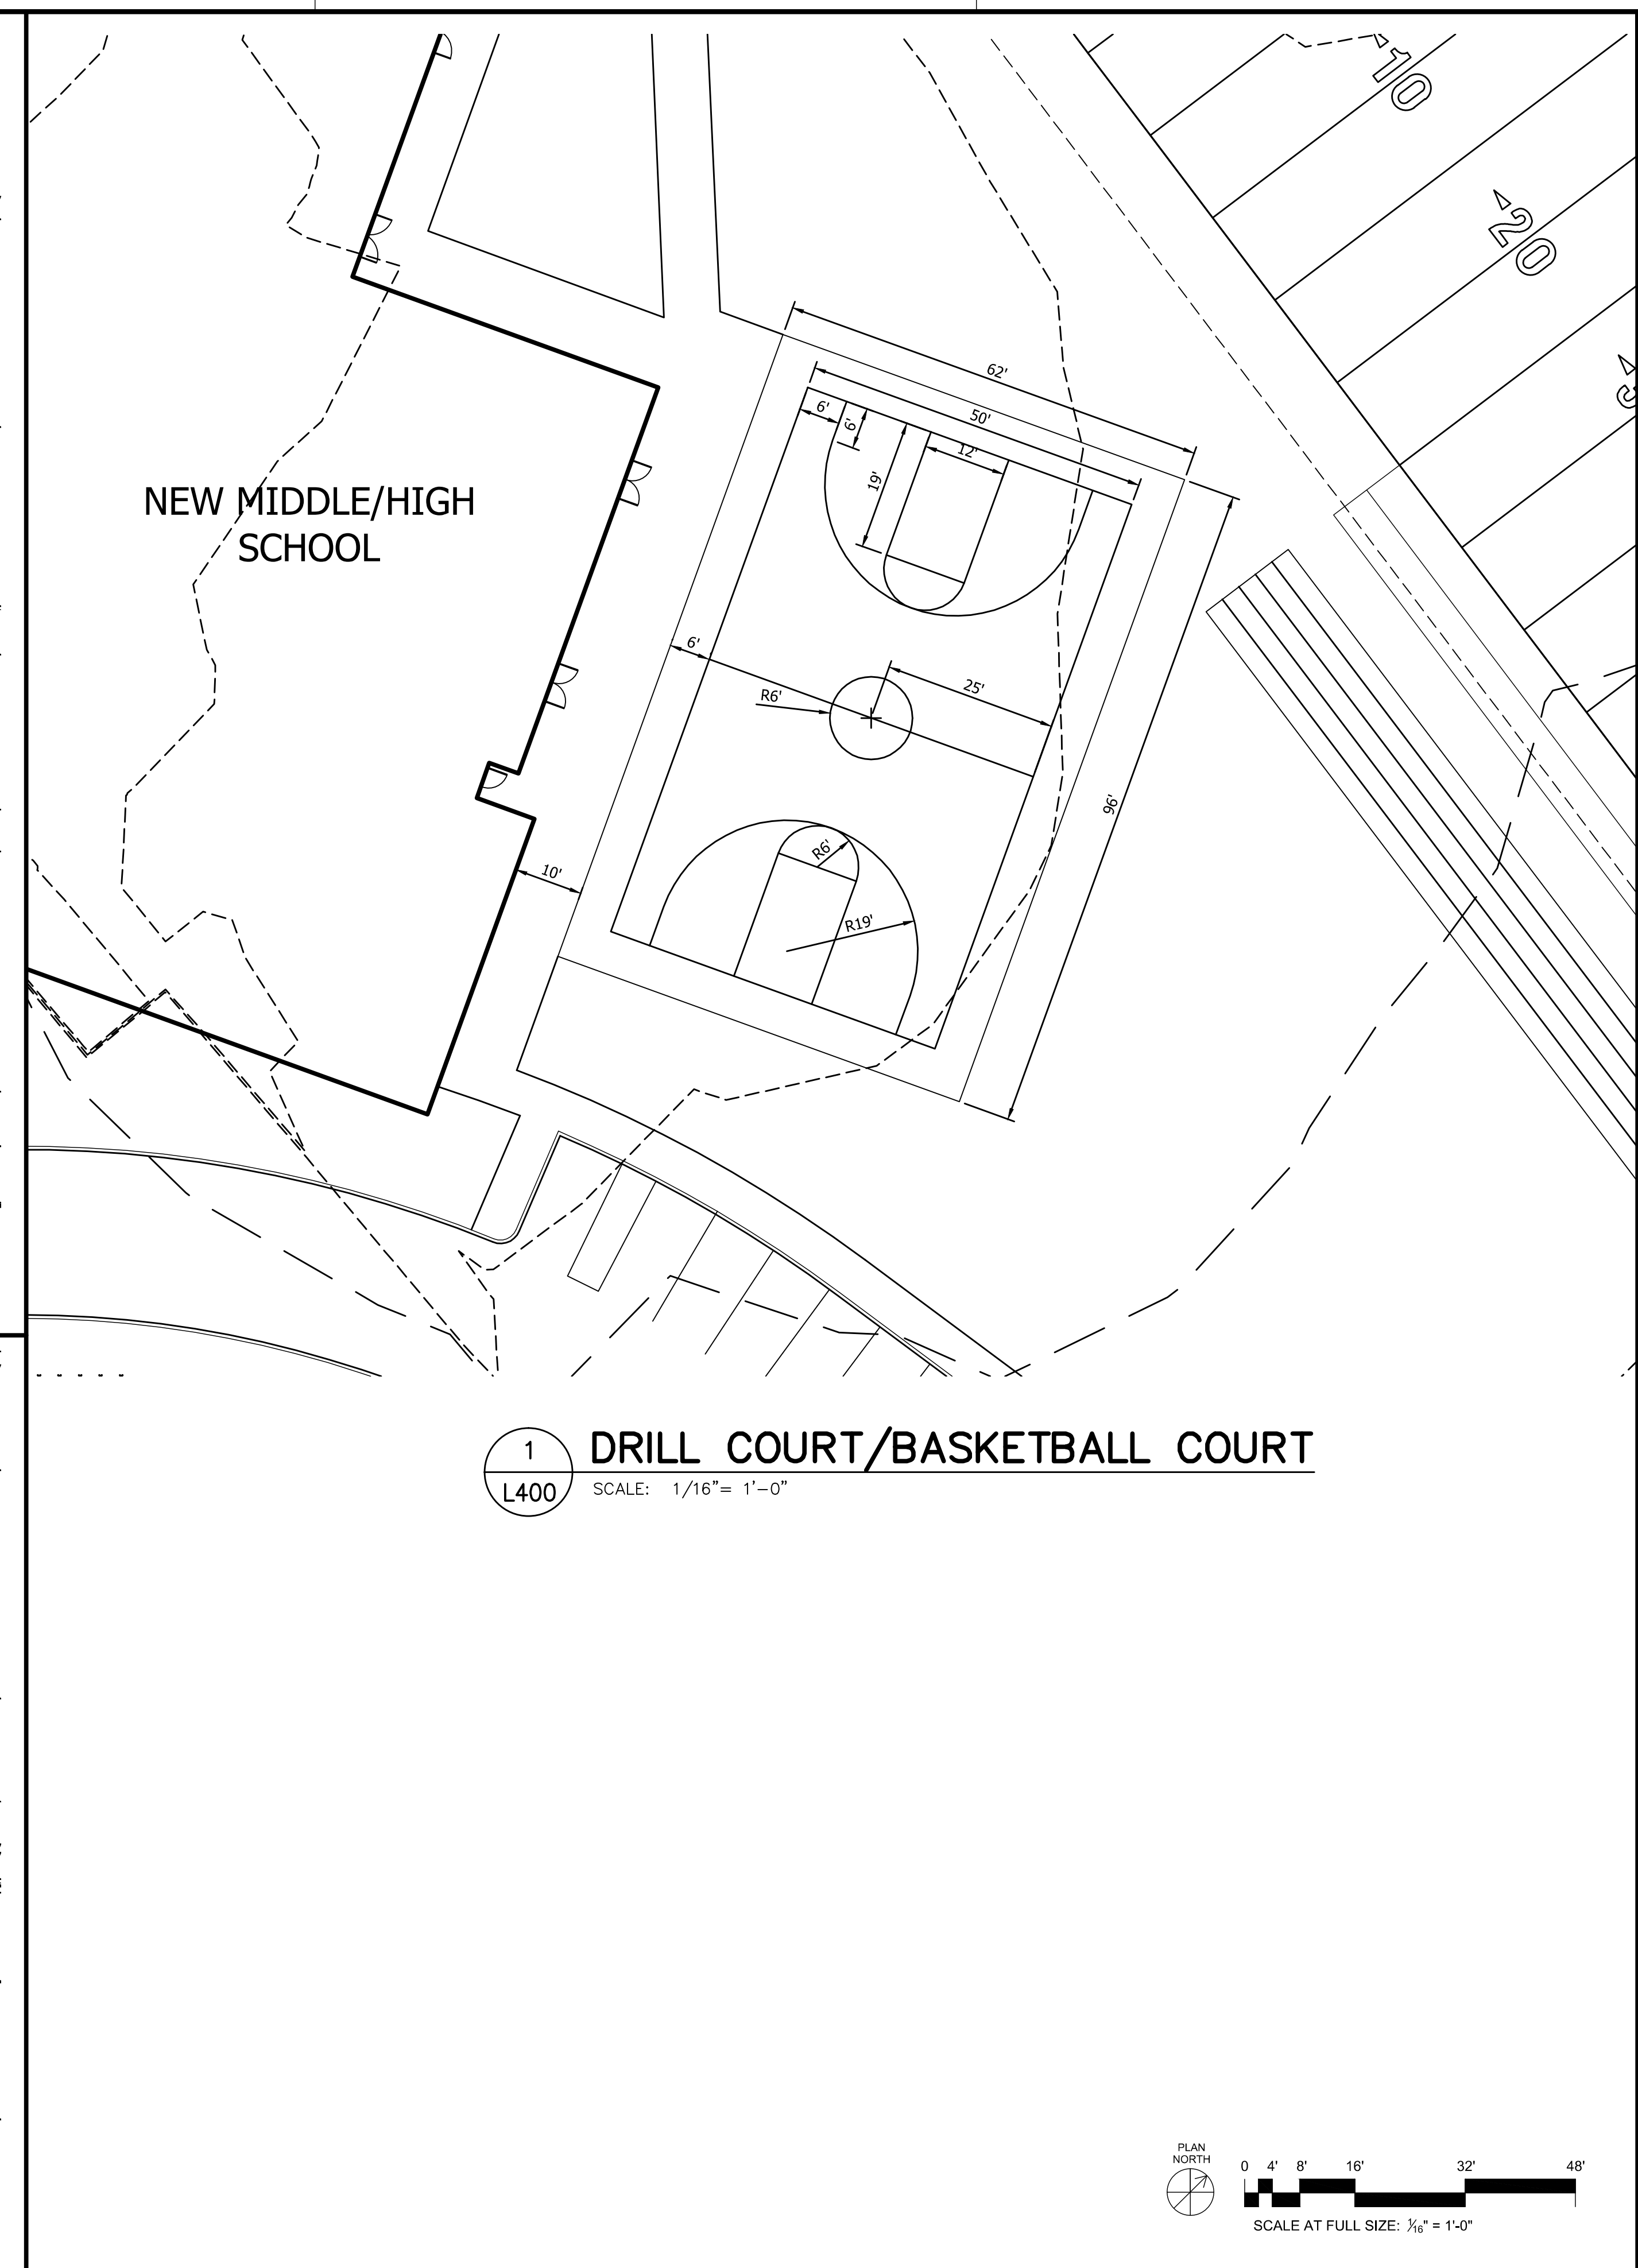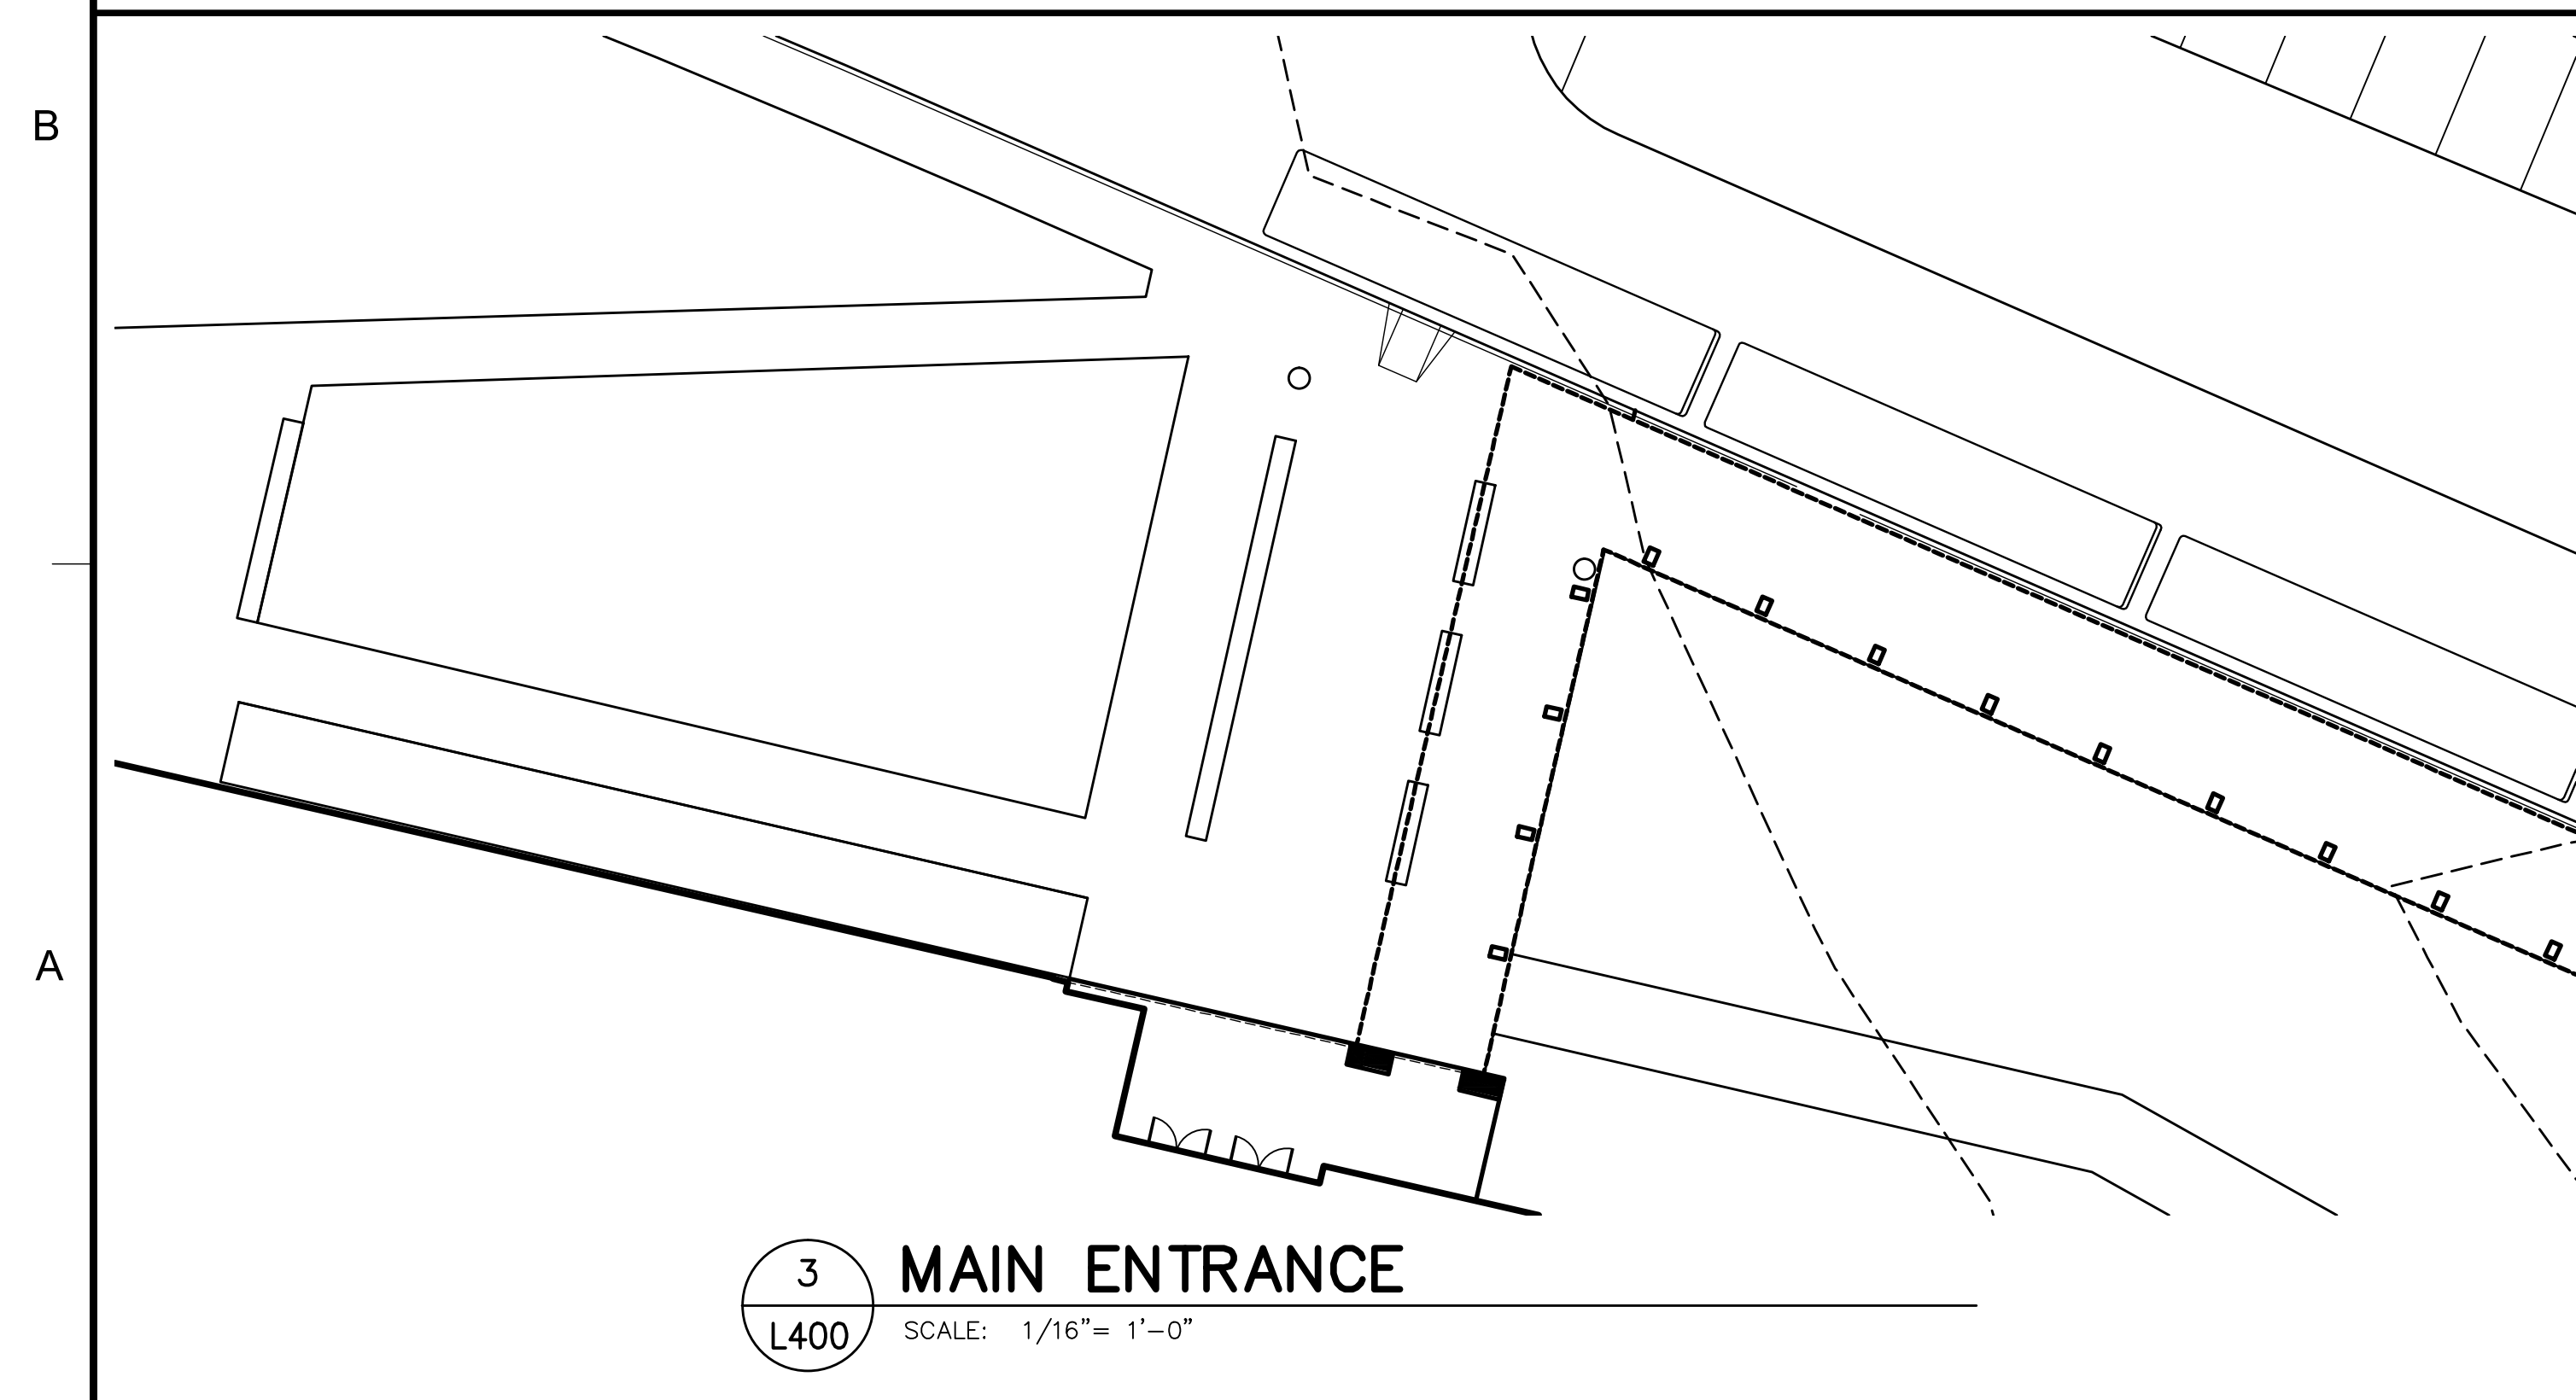SCALE: 1/16" = 1'-0"




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MARINE CORPS BASE QUANTICO, VIRGINIA		
QUANTICO, VA		
REPLACE QUANTICO M/H SCHOOL		
LANDSCAPE ARCHITECTURAL SITE PLAN ENLARGEMENTS		
SCALE: 1" = 16'		
PROJECT NO.: AM000021		
CONSTR. CONTR. NO.		
NAVFAC DRAWING NO.		
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L401		
DRAWN BY: 10 MARCH 2009		



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MARINE CORPS BASE QUANTICO, VIRGINIA		
QUANTICO, VA		
REPLACE QUANTICO M/H SCHOOL		
LANDSCAPE ARCHITECTURAL SITE PLAN ENLARGEMENTS		
SCALE: 1" = 16'		
PROJECT NO.: AM0000021		
CONSTR. CONTR. NO.		
NAVFAC DRAWING NO.		
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DRAWN/FORM REVISION: 10 MARCH 2009		

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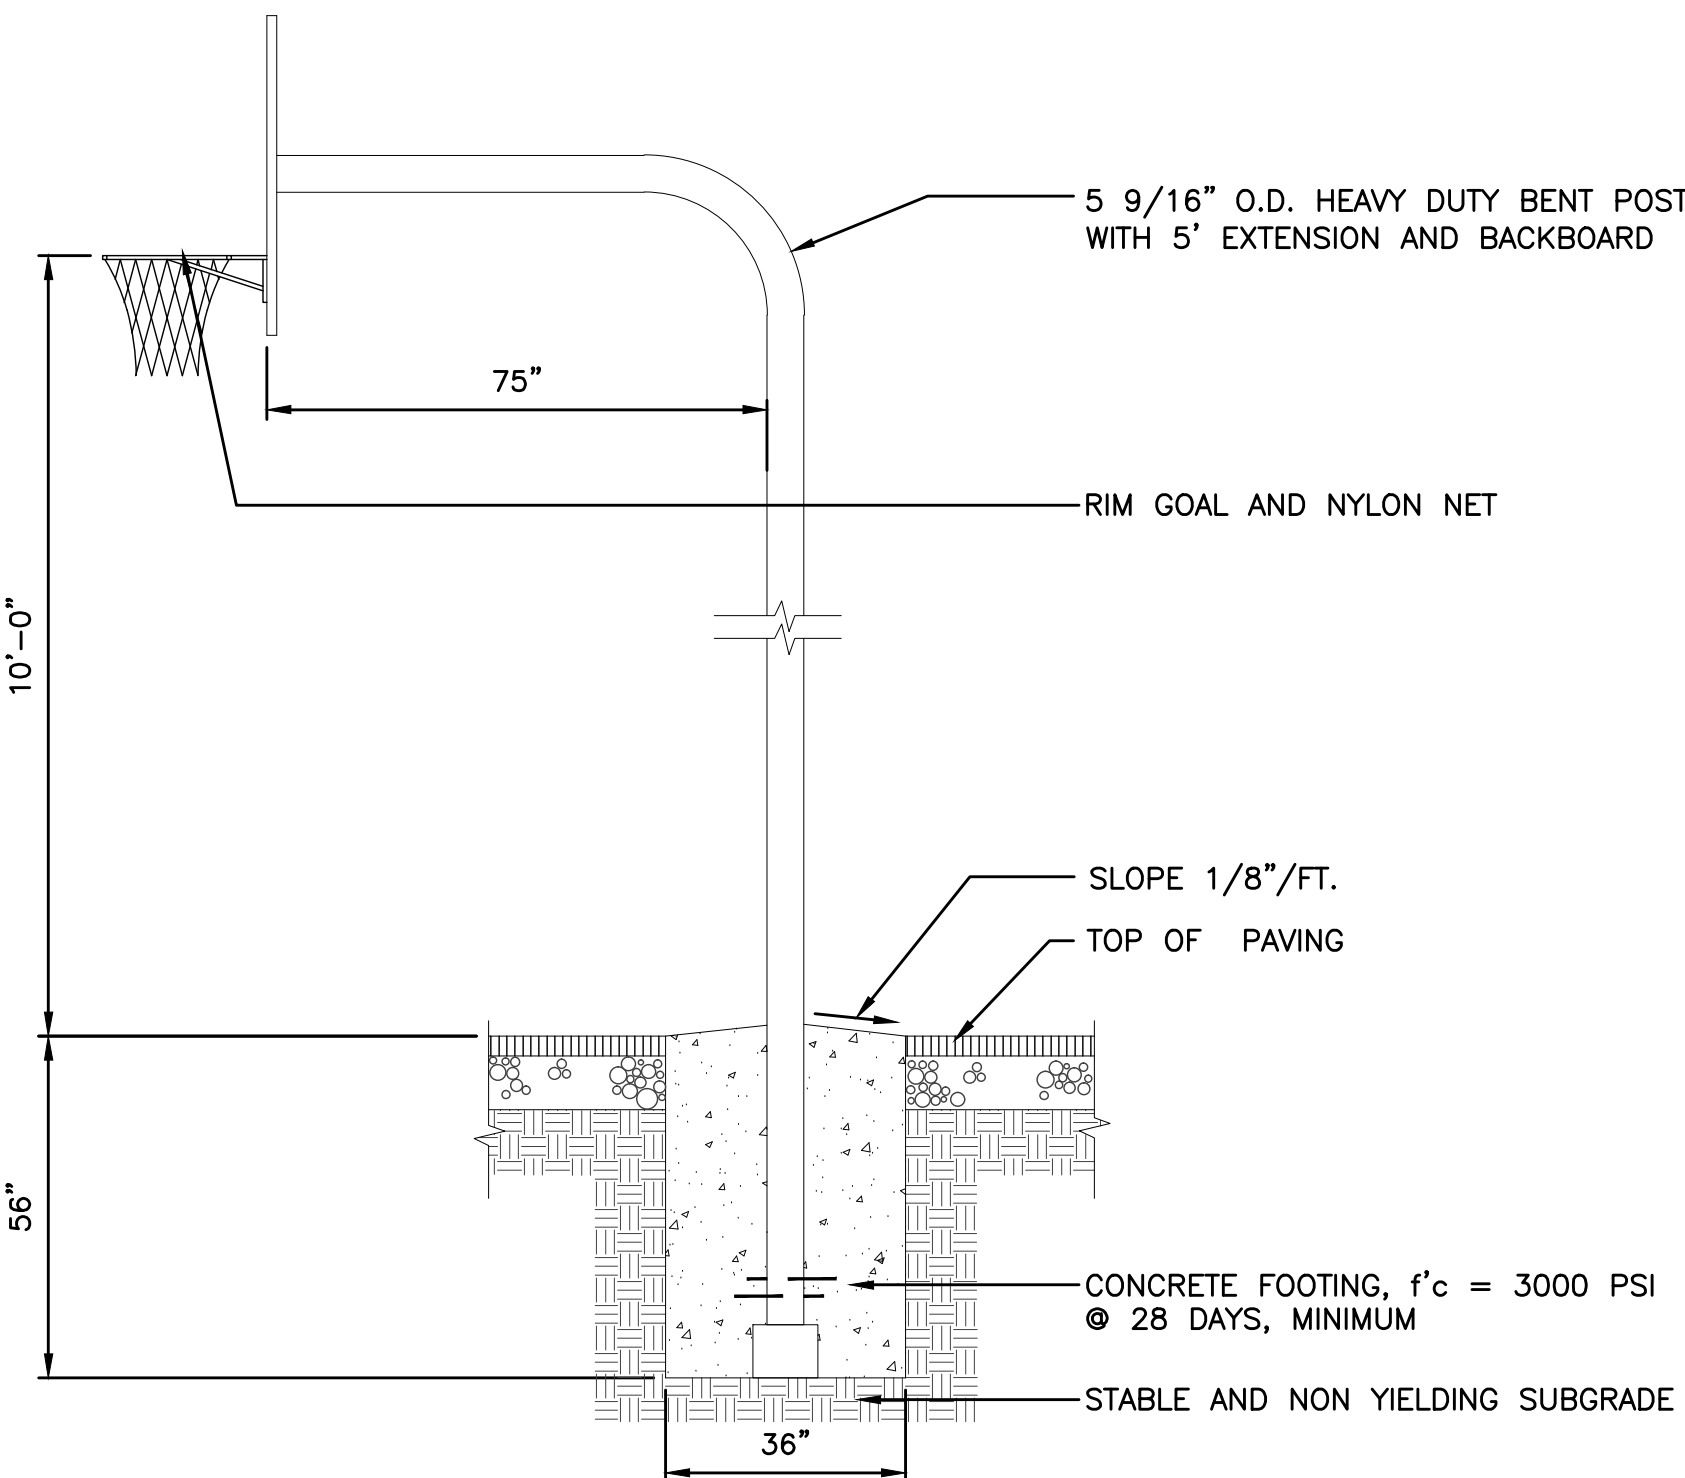


NOTE:
1. ALL LINES SHALL BE 2" WIDE PAINTED WHITE, UNLESS NOTED OTHERWISE.
2. AREA NOT COLORCOATED SHALL BE SEALCOATED BLACK

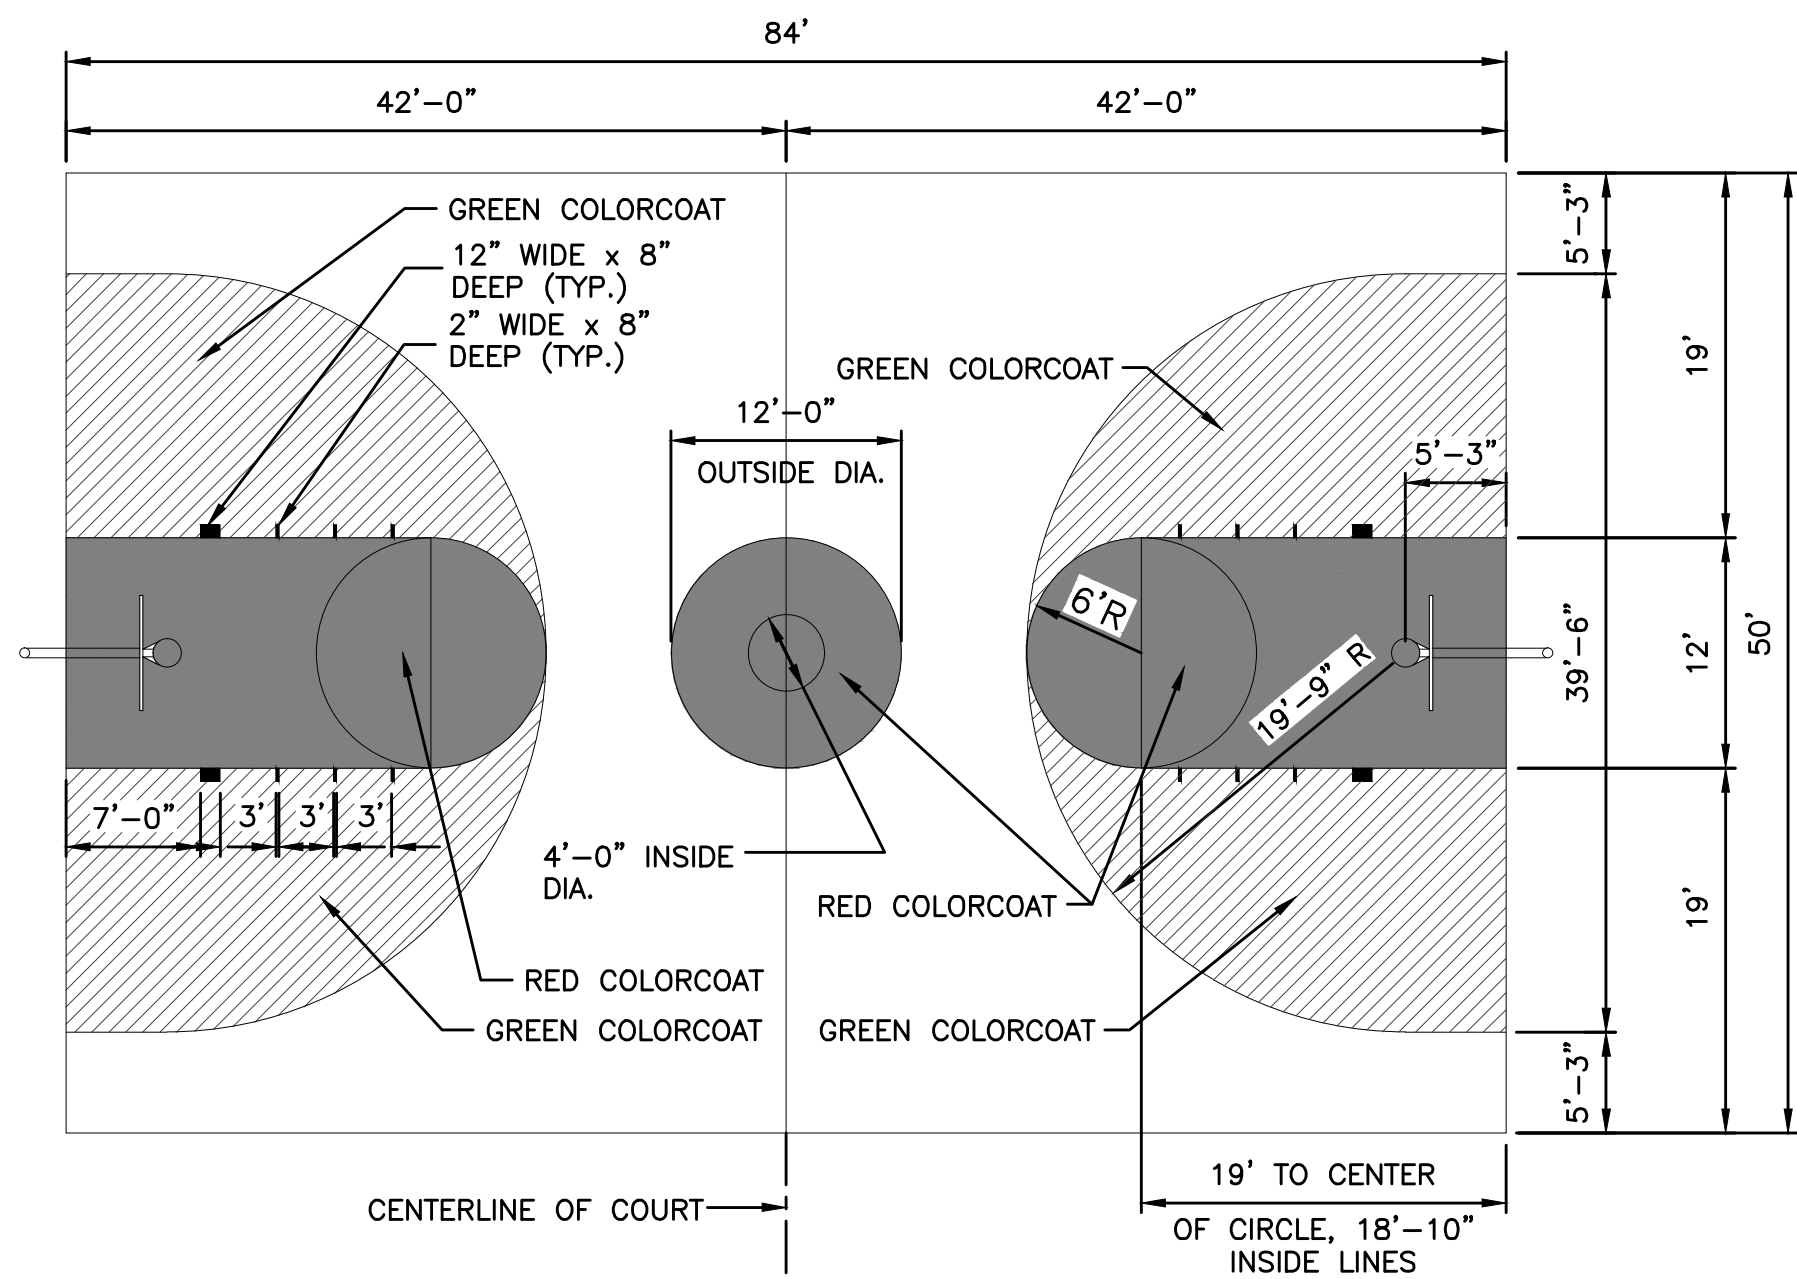
3 BASKETBALL COURT LAYOUT
L500 NOT TO SCALE

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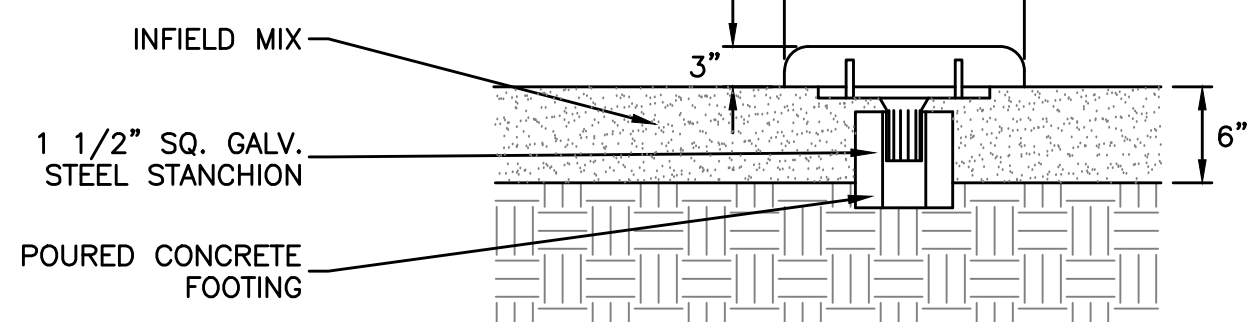
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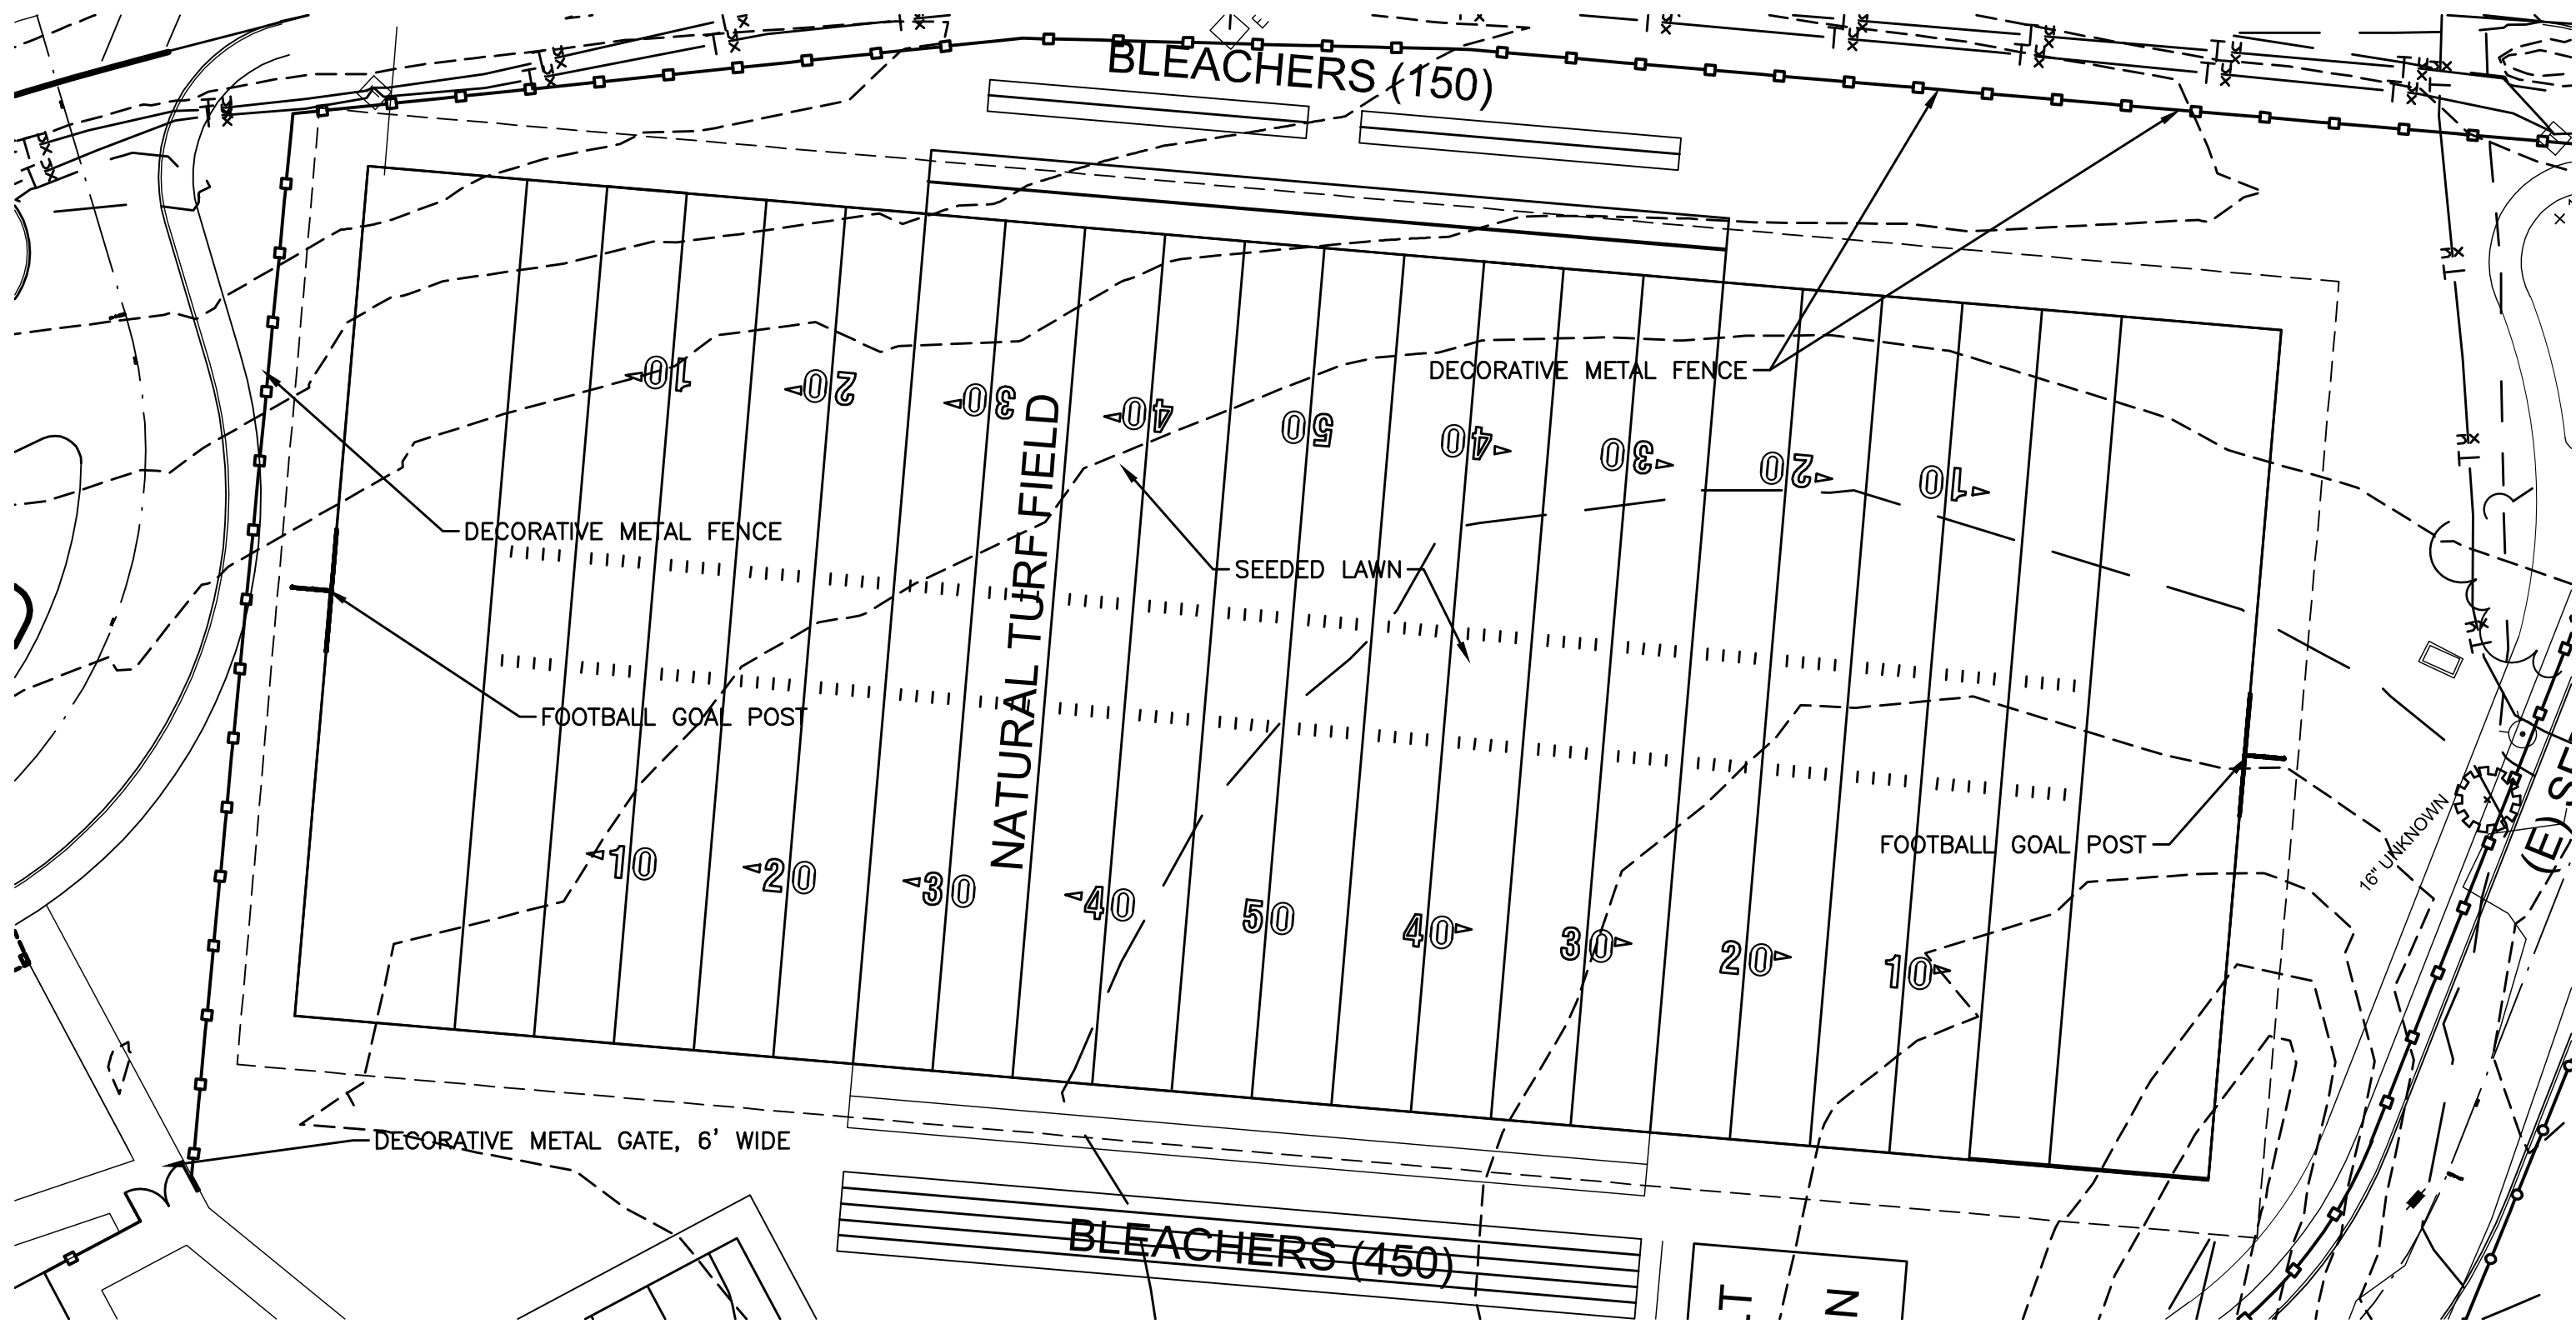
6 BASKETBALL STANDARD
L500 NOT TO SCALE




4 HOME PLATE
L500 NOT TO SCALE

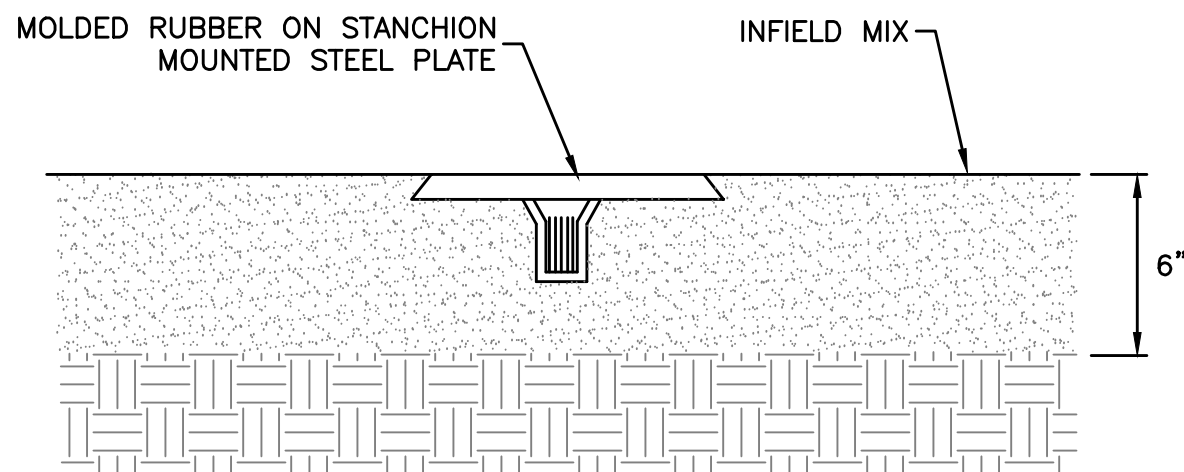

5 BASE
L500 NOT TO SCALE



1 FOOTBALL FIELD
L500 1" = 30'-0"

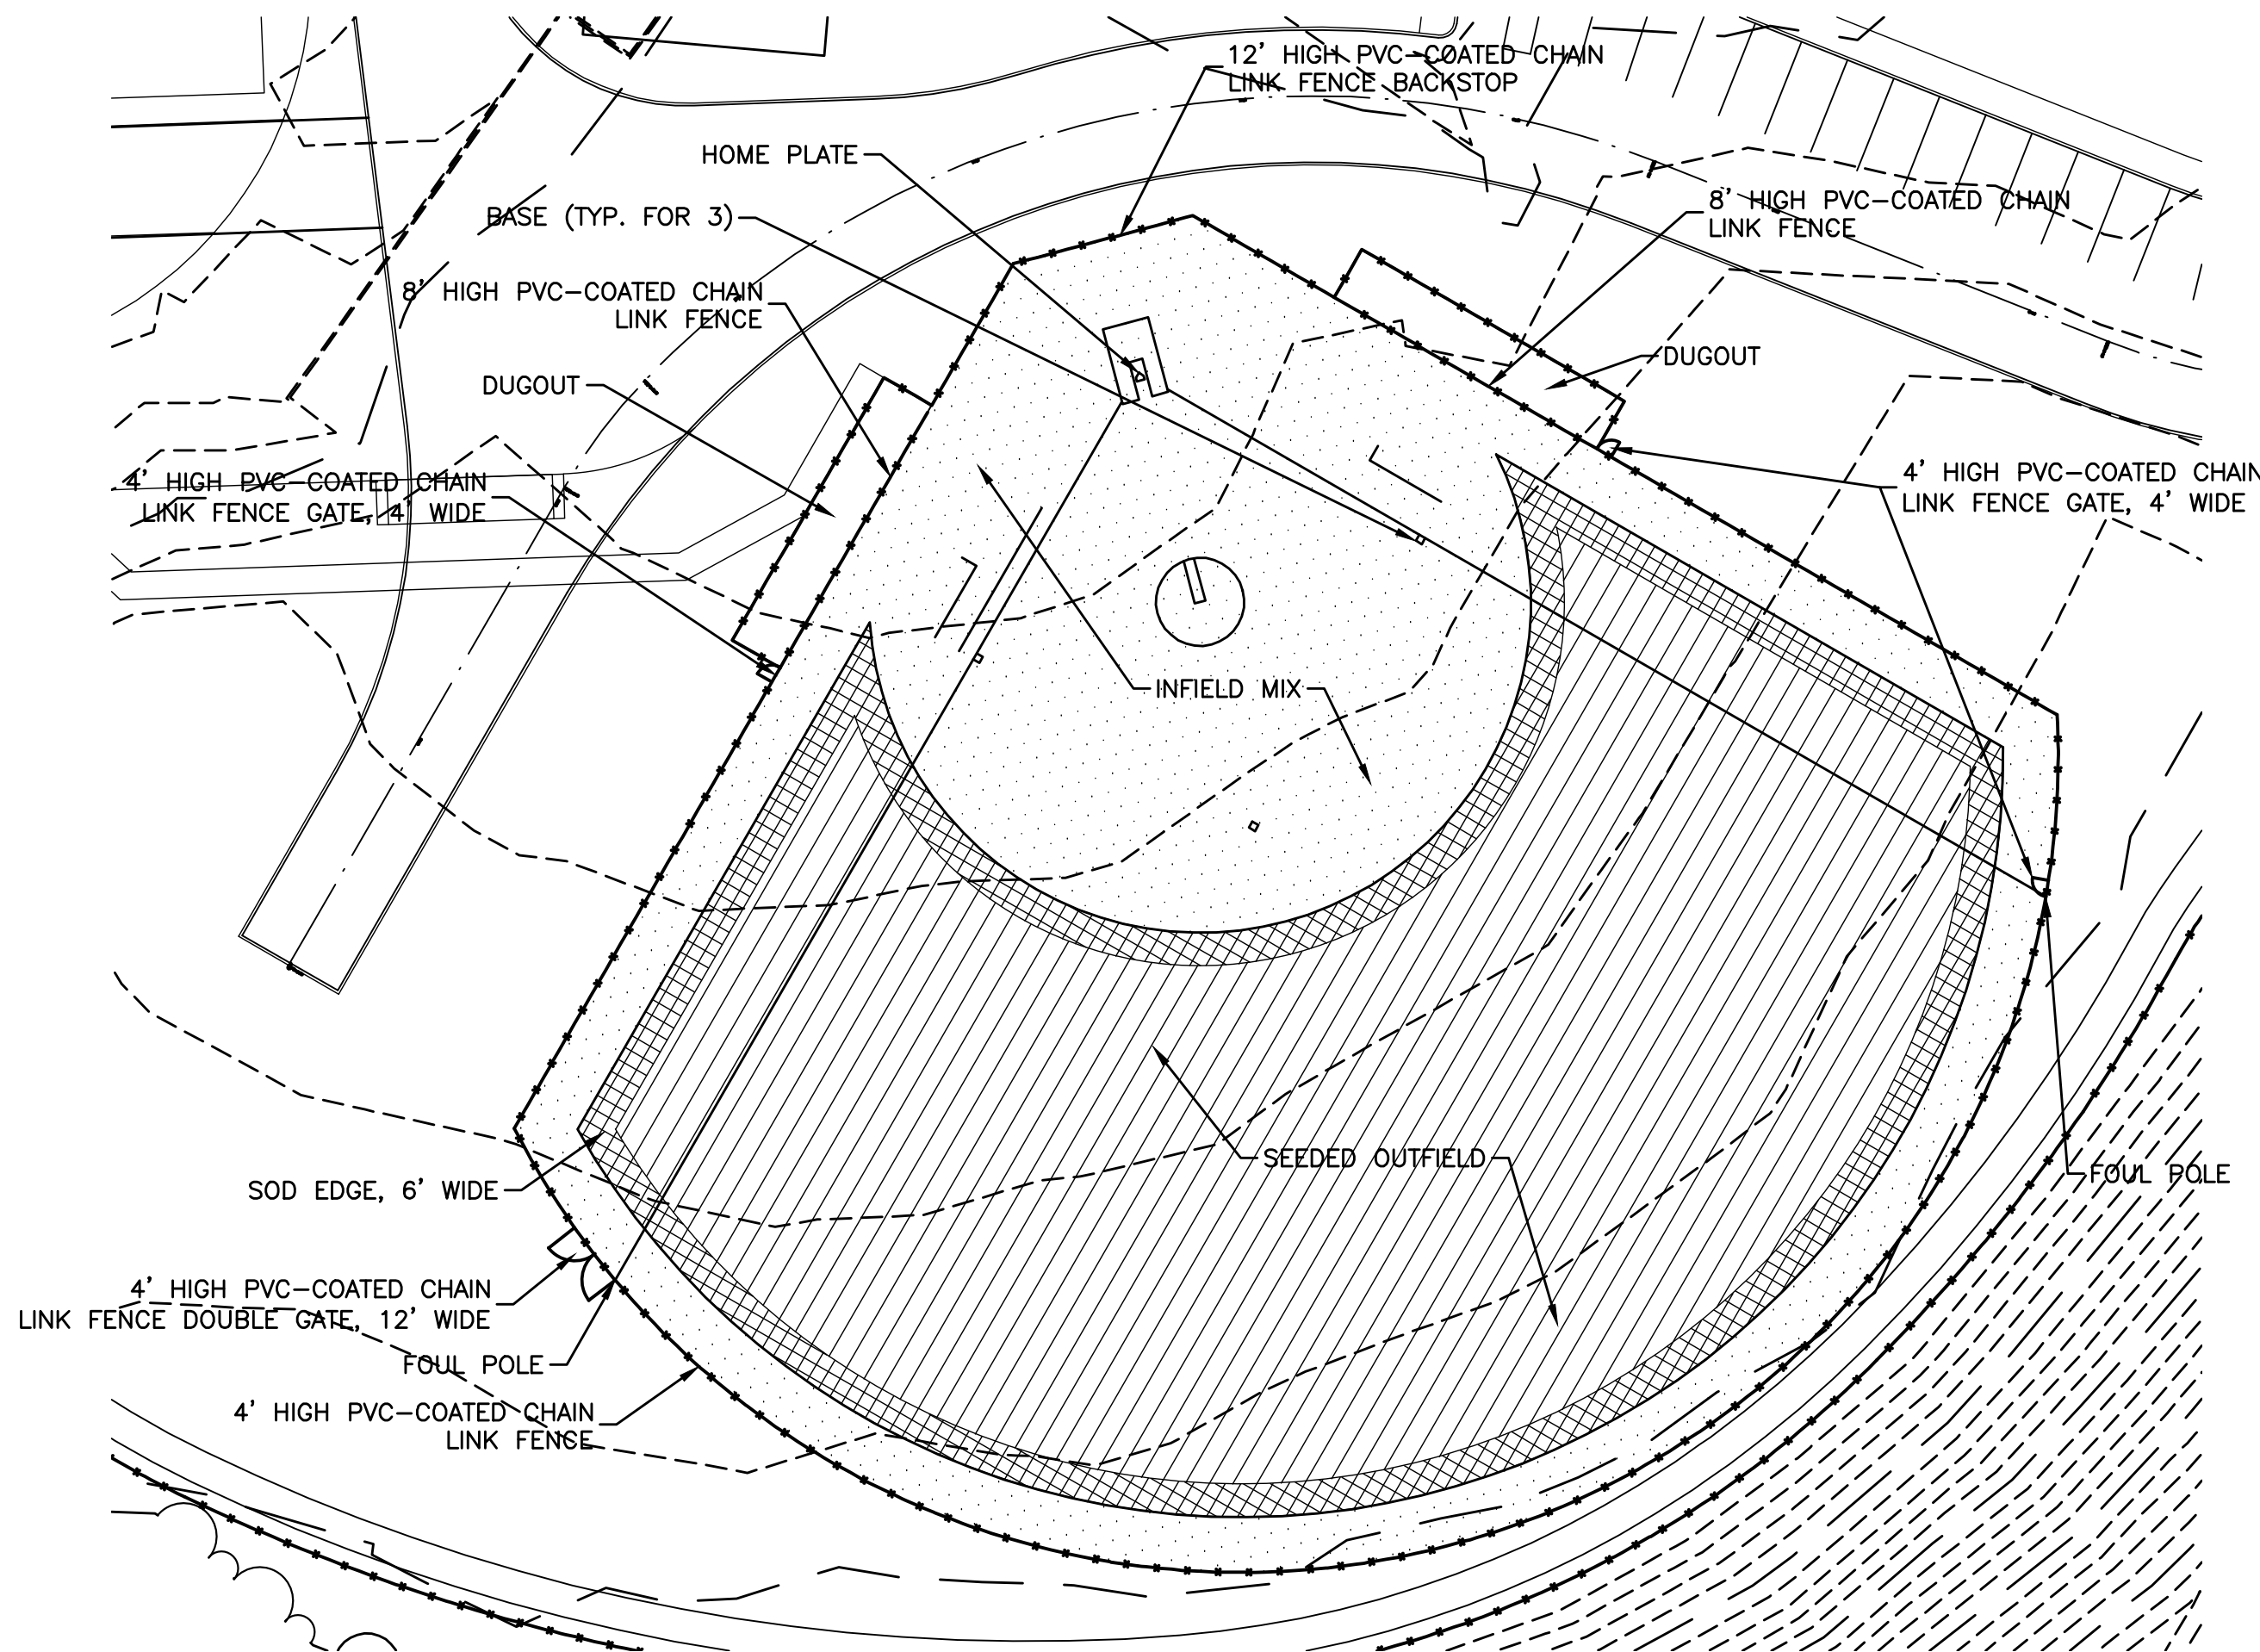

2 BASEBALL FIELD ENLARGEMENT
L500 1" = 30'-0"

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NAVAL FACILITIES ENGINEERING COMMAND - WASHINGTON
MARINE CORPS BASE QUANTICO, VIRGINIA
QUANTICO, VA
REPLACE QUANTICO M/H SCHOOL
LANDSCAPE ARCHITECTURAL DETAILS

D

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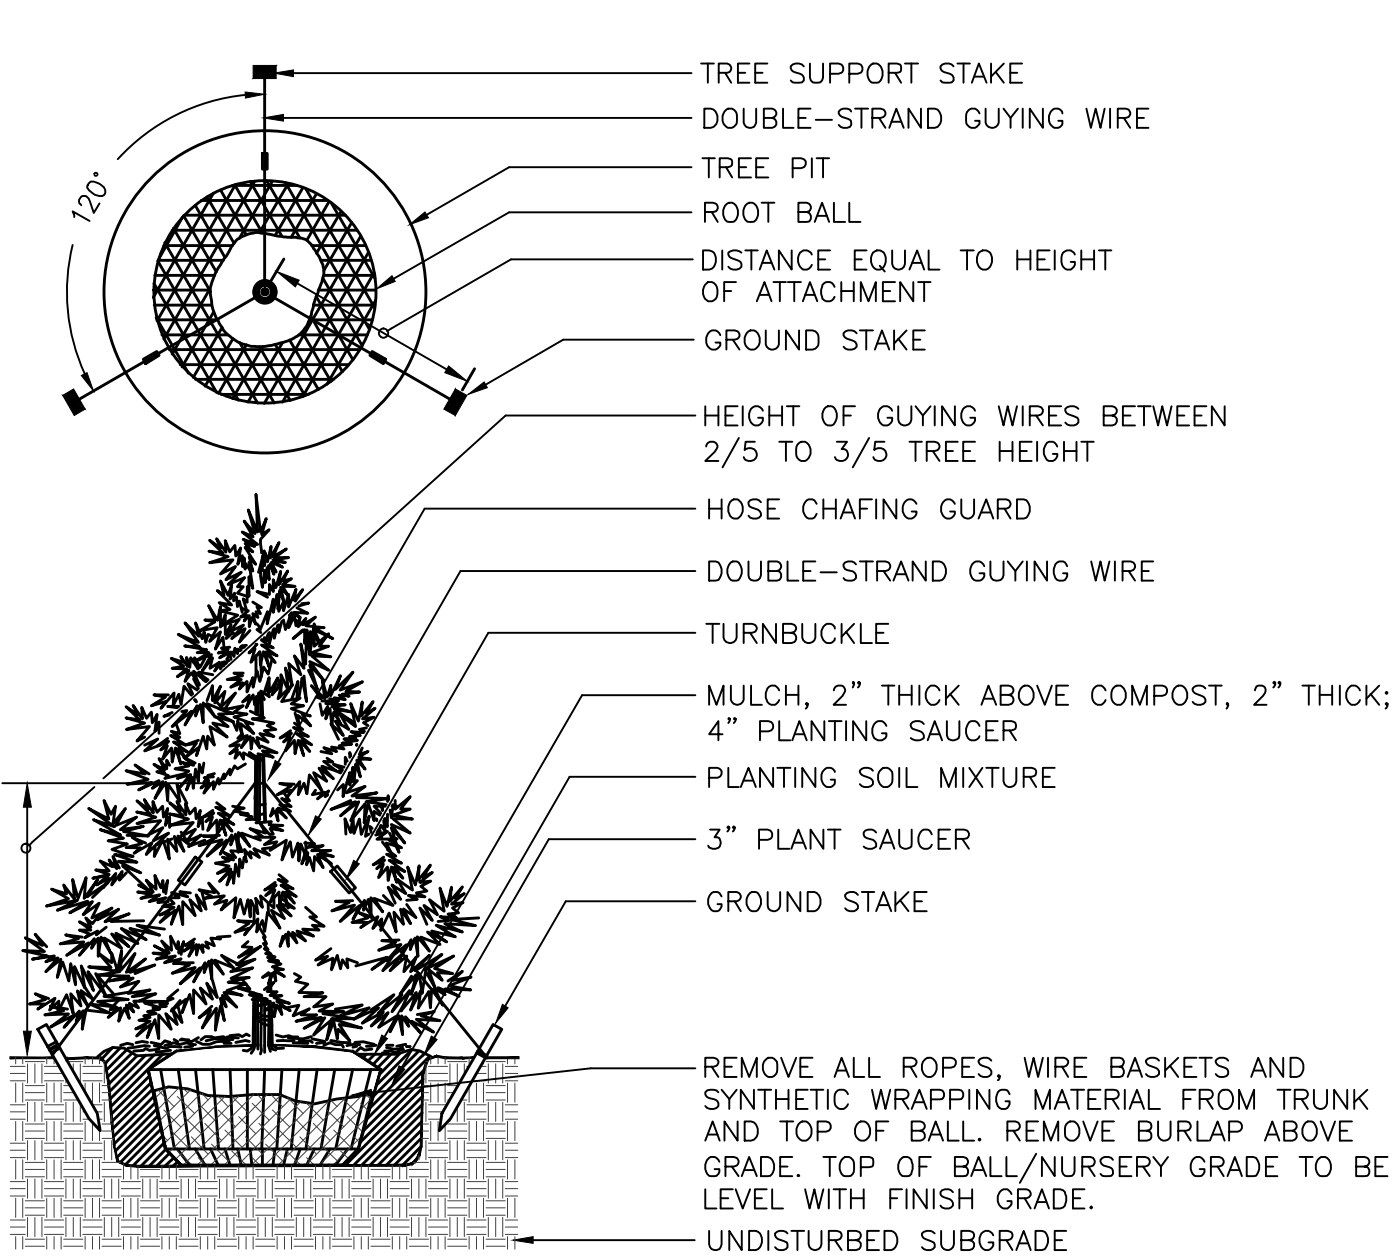
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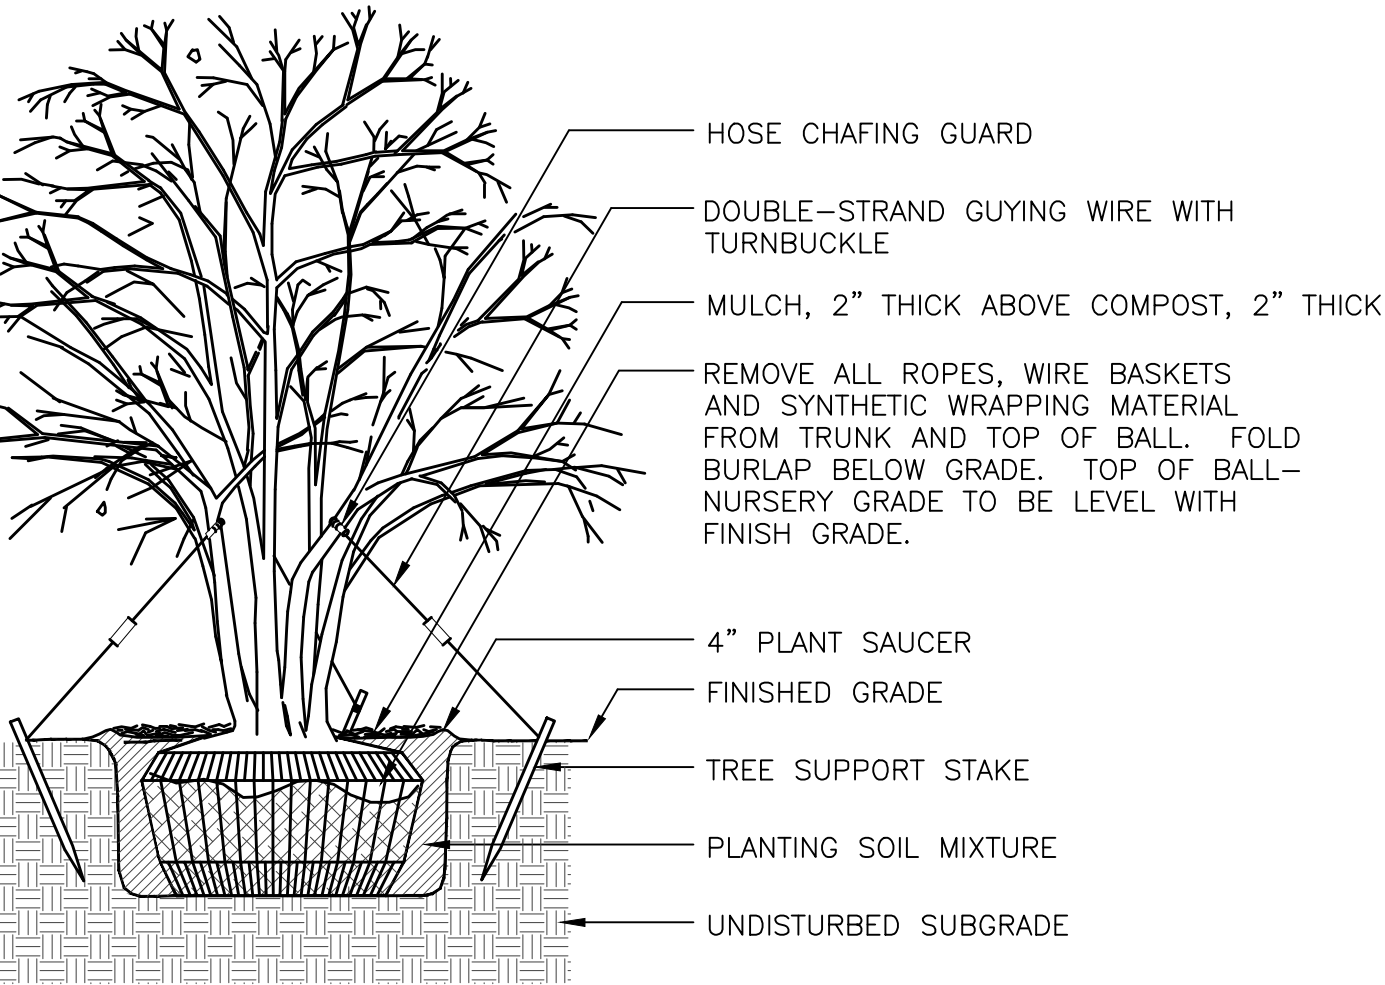
PLANT MATERIALS LIST						
QTY	KEY	BOTANICAL NAME	COMMON NAME	SIZE	ROOT	REMARKS
		DECIDUOUS AND MULTI-STEM TREES				
XX	AR	ACER RUBRUM 'RED SUNSET'	RED SUNSET RED MAPLE	4 1/2"-5" CAL	B&B	SINGLE-STEM, SPECIMEN
XX	AC	AMELANCHIER CANADENSIS	SHADBLOW SERVICEBERRY	12'-14' HT.	B&B	MULTI-STEM, MIN. 3 TRUNKS
XX	CF1	CORNUS FLORIDA 'APPALACHIAN SPRING'	APPALACHIAN SPRING FLOWERING DOGWOOD	3"-3 1/2" CAL.	B&B	SINGLE-STEM, SPECIMEN
XX	LS	LIQUIDAMBAR STYRICIFLUA 'CHEROKEE'	CHEROKEE SWEETGUM	4 1/2"-5" CAL	B&B	SINGLE-STEM, SPECIMEN
XX	LT	LIRIODENDRON TULIIFERA	TULIP POPLAR	4 1/2"-5" CAL	B&B	SINGLE-STEM, SPECIMEN
XX	MV	MAGNOLIA VIRGINIANA	SWEETBAY MAGNOLIA	12'-14' HT.	B&B	MULTI-STEM, MIN. 3 TRUNKS
XX	NS	NYSSA SYLVATICA	BLACK GUM	4 1/2"-5" CAL	B&B	SINGLE-STEM, SPECIMEN
XX	QA	QUERCUS ALBA	WHITE OAK	4 1/2"-5" CAL	B&B	SINGLE-STEM, SPECIMEN
XX	QR	QUERCUS RUBRA	NORTHERN RED OAK	4 1/2"-5" CAL	B&B	SINGLE-STEM, SPECIMEN
		EVERGREEN TREES				
XX	PS	PINUS STROBUS	EASTERN WHITE PINE	14'-16' HT.	B&B	HEAVY
		SHRUBS				
XX	CL	CLETHRA ALNIFOLIA 'RUBY SPICE'	'RUBY SPICE' CLETHRA	24"-30"	B&B	36" O.C. SPACING
XX	HQ	HYDRANGEA QUERCIFOLIA 'SNOW QUEEN'	OAKLEAF HYDRANGEA	24"-30"	B&B	36" O.C. SPACING
XX	IT	ITEA VIRGINICA 'HENRY'S GARNET'	HENRY'S GARNET SWEETSPIRE	24"-30"	B&B	36" O.C. SPACING
XX	VT	VIBURNUM TRILOBUM 'BAILEY COMPACT'	AMERICAN CRANBERRYBUSH	24"-30"	B&B	48" O.C. SPACING
		PERENNIALS AND GROUNDCOVERS				
XX	CB	CAREX FLACCA 'BLUE ZINGER'	BLUE ZINGER GLAUCOUS SEDGE	#1 CONT.		12" O.C. SPACING
XX	CP	CERATOSTIGMA PLUMBAGINOIDES	PLUMBAGO	#1 CONT.		12" O.C. SPACING
XX	DC	DESCHAMPSIA CESPITOSA	TUFTED HAIR GRASS	#1 CONT.		18" O.C. SPACING
XX	JE	JUNCUS EFFUSUS	SMOOTH RUSH	#1 CONT.		18" O.C. SPACING
XX	LM	LIRIOPE MUSCARI 'VARIEGATA'	VARIEGATED LIRIOPE	SP#4		12" O.C. SPACING
XX	PV	PANICUM VIRGATUM 'SHENANDOAH'	SHENANDOAH SWITCHGRASS	#1 CONT.		18" O.C. SPACING
XX	ST	SEDUM TERNATUM 'LARINUM PARK'	LARINUM PARK STONECROP	SP#4		10" O.C. SPACING
XX	SL	SISYRINCHIU ANGUSTIFOLIUM 'LUCERNE'	LUCERNE BLUE EYED GRASS	#1 CONT.		10" O.C. SPACING
XX	VM	VINCA MINOR	PERIWINKLE	SP#4		6" O.C. SPACING
	FF	FINE FESCUE MIX	NO-MOW TURF			SEE TURF SPEC'S

PLANTING NOTES AND SPECIFICATIONS

1. THE CONTRACTOR SHALL FURNISH AND PLANT ALL PLANTS SHOWN ON THE DRAWINGS, AS SPECIFIED, AND IN QUANTITIES INDICATED ON THE PLAN.
2. ALL PLANTS SHALL BE NURSERY GROWN.
3. ALL PLANTS SHALL BE IN ACCORDANCE WITH THE AMERICAN STANDARD FOR NURSERY STOCK, LATEST EDITION.
4. ALL PLANTS SHALL BE HARDY UNDER CLIMATIC CONDITIONS SIMILAR TO THOSE IN THE LOCALITY OF THE PROJECT.
5. ALL PLANTS SHALL BE TYPICAL OF THEIR SPECIES OR VARIETY AND SHALL HAVE A NORMAL HABIT OF GROWTH. THEY SHALL BE SOUND, HEALTHY, VIGOROUS, WELL BRANCHED AND DENSELY FOLIATED WHEN IN LEAF. THEY SHALL BE FREE OF DISEASE AND INSECT PESTS, EGGS, AND LARVAE. THEY SHALL HAVE HEALTHY, WELL DEVELOPED ROOT SYSTEMS.
6. SUBSTITUTIONS: WHEN PLANTS OF A SPECIFIED KIND OR SIZE ARE NOT AVAILABLE WITHIN A REASONABLE DISTANCE, SUBSTITUTIONS MAY BE MADE UPON REQUEST BY THE CONTRACTOR, IF APPROVED BY THE LANDSCAPE ARCHITECT.
7. MEASUREMENT: DIMENSIONS OF TREES AND SHRUBS SHALL CONFORM TO THE AMERICAN STANDARD FOR NURSERY STOCK, LATEST EDITION.
8. SIZE: ALL PLANTS SHALL CONFORM TO THE MEASUREMENTS SPECIFIED ON THE PLANT LIST, UNLESS AUTHORIZED IN WRITING BY THE LANDSCAPE ARCHITECT.
9. BALLED AND BURLAPPED PLANTS SHALL BE DUG WITH FIRM NATURAL BALLS OF EARTH, OF DIAMETER AND DEPTH TO INCLUDE MOST OF THE FIBROUS ROOTS. CONTAINER GROWN STOCK SHALL HAVE BEEN GROWN IN A CONTAINER LONG ENOUGH FOR THE ROOT SYSTEM TO HAVE DEVELOPED SUFFICIENTLY TO HOLD ITS SOIL TOGETHER FIRM AND WHOLE. NO PLANTS SHALL BE LOOSE IN THE CONTAINER.
10. ROOT BALLS OF ALL PLANTS SHALL BE ADEQUATELY PROTECTED AT ALL TIMES FROM SUN AND DRYING WINDS OR FROST.
11. LANDSCAPE ARCHITECT SHALL BE NOTIFIED ONE WEEK PRIOR TO BEGINNING PLANTING OPERATIONS.
12. PLANTS WITH BROKEN ROOT BALLS OR EXCESSIVE DAMAGE TO THE CROWN SHALL BE REJECTED AND BE REPLACED PRIOR TO PLANTING.
13. ALL TREE WRAP SHALL BE REMOVED IMMEDIATELY AFTER TREES ARE PLANTED.
14. EACH TREE OR SHRUB SHALL BE PRUNED IN ACCORDANCE WITH THE AMERICAN ASSOCIATION OF NURSERYMEN STANDARDS TO PRESERVE THE NATURAL CHARACTER OF THE PLANT. ALL DEAD WOOD OR SUCKERS AND ALL BROKEN OR BADLY BRUISED BRANCHES SHALL BE REMOVED.
15. MULCH: IMMEDIATELY AFTER PLANTING OPERATIONS ARE COMPLETED, ALL TREE AND SHRUB PLANTING PITS SHALL BE COVERED WITH A 2" (TWO INCH) LAYER OF COMPOST FOLLOWED BY A 2" (TWO INCH) LAYER OF SHREDDED HARDWOOD BARK MULCH OR OTHER MATERIAL APPROVED BY THE LANDSCAPE ARCHITECT. MULCH SHALL NOT TOUCH TRUNK OR STEM OF TREES, SHRUBS AND HERBACEOUS PERENNIALS.
16. COMPOST SHALL BE MATURE, WEED-FREE AND UNTREATED BY LIMING AGENTS OR ASH BYPRODUCTS. COMPOST SHALL NOT TOUCH TRUNK OR STEM OF TREES, SHRUBS AND HERBACEOUS PERENNIALS.
17. ALL EVERGREENS AND TREES IN LEAF WHEN PLANTED SHALL BE TREATED WITH ANTI-DESICCANT SUCH AS "WILT-PROOF".
18. PLANTING SOIL AND BACKFILL MIX SHALL CONSIST OF TOP SOIL AND ECOSOIL AMENDMENT MIXTURES.
19. CONTRACTOR SHALL MAINTAIN ALL PLANT MATERIAL UNTIL FINAL ACCEPTANCE BY OWNER. A GUARANTEE AND MAINTENANCE PERIOD SHALL COMMENCE UPON FINAL ACCEPTANCE BY OWNER.
20. GUARANTEE: ALL PLANT MATERIAL SHALL BE GUARANTEED AND MAINTAINED BY THE CONTRACTOR FOR A PERIOD OF NOT LESS THAN ONE FULL YEAR FROM THE DATE OF FINAL ACCEPTANCE BY OWNER. IT SHALL BE THE CONTRACTOR'S RESPONSIBILITY TO MONITOR THE PROJECT DURING THE GUARANTEE PERIOD AND NOTIFY THE OWNER IF PROBLEMS DEVELOP WITH THE PLANT MATERIAL. ANY MATERIAL THAT IS 25% DEAD, OR MORE, SHALL BE CONSIDERED DEAD AND MUST BE REPLACED AT NO CHARGE. A TREE SHALL BE CONSIDERED DEAD WHEN THE MAIN LEADER HAS DIED BACK, OR WHEN 25% OF THE CROWN IS DEAD.
21. ALL PLANTING SHALL BE AT THE LOCATIONS INDICATED ON THE DRAWINGS. THE CONTRACTOR SHALL BE RESPONSIBLE FOR PLANTING AT THE CORRECT GRADES, ALIGNMENT, AND TO THE INDICATED LAYOUT OF THE PLANTING BEDS. MINOR ADJUSTMENTS TO PLANTING LOCATIONS MAY BE NECESSARY DUE TO FIELD CONDITIONS AND FINAL GRADING. THE CONTRACTOR SHALL NOTIFY THE OWNER IF MAJOR ADJUSTMENTS ARE REQUIRED.
22. LAYOUT OF PLANTING: THE CONTRACTOR SHALL LAYOUT WITH IDENTIFIABLE STAKES THE LOCATION OF ALL PLANTS, ARRANGEMENT AND OUTLINES OF PLANTING BEDS AS INDICATED ON THE DRAWING. THE LAYOUT OF PLANTING SHALL BE APPROVED BY THE LANDSCAPE ARCHITECT PRIOR TO ANY EXCAVATION OF PLANT PITS OR PLANT BEDS. LANDSCAPE ARCHITECT SHALL BE ON SITE DURING PLANTING OPERATIONS.
23. CONDITIONS DETRIMENTAL TO PLANTS: THE CONTRACTOR SHALL NOTIFY THE OWNER OR HIS REPRESENTATIVE IN WRITING OF ALL SOIL OR DRAINAGE CONDITIONS WHICH THE CONTRACTOR CONSIDERS DETRIMENTAL TO THE GROWTH OF PLANTS. HE SHALL STATE THE CONDITIONS AND SUBMIT A PROPOSAL FOR CORRECTING THE CONDITIONS, INCLUDING ANY CHANGE IN COST, FOR REVIEW AND ACCEPTANCE BY THE OWNER OR HIS REPRESENTATIVE.
24. ALL PLANTS TO BE SELECTED AND TAGGED IN THE FIELD BY THE LANDSCAPE ARCHITECT.
25. ALL LANDSCAPING SHALL BE GUARANTEED BY INSTALLER FOR ONE YEAR AND THEREAFTER BY OWNER.




4 EVERGREEN TREE PLANTING
L501 NOT TO SCALE




NOTES:
1. PLACE GUY WIRES AT 1/3 TREE HEIGHT.

5 MULTI-STEM TREE PLANTING
L501 NOT TO SCALE

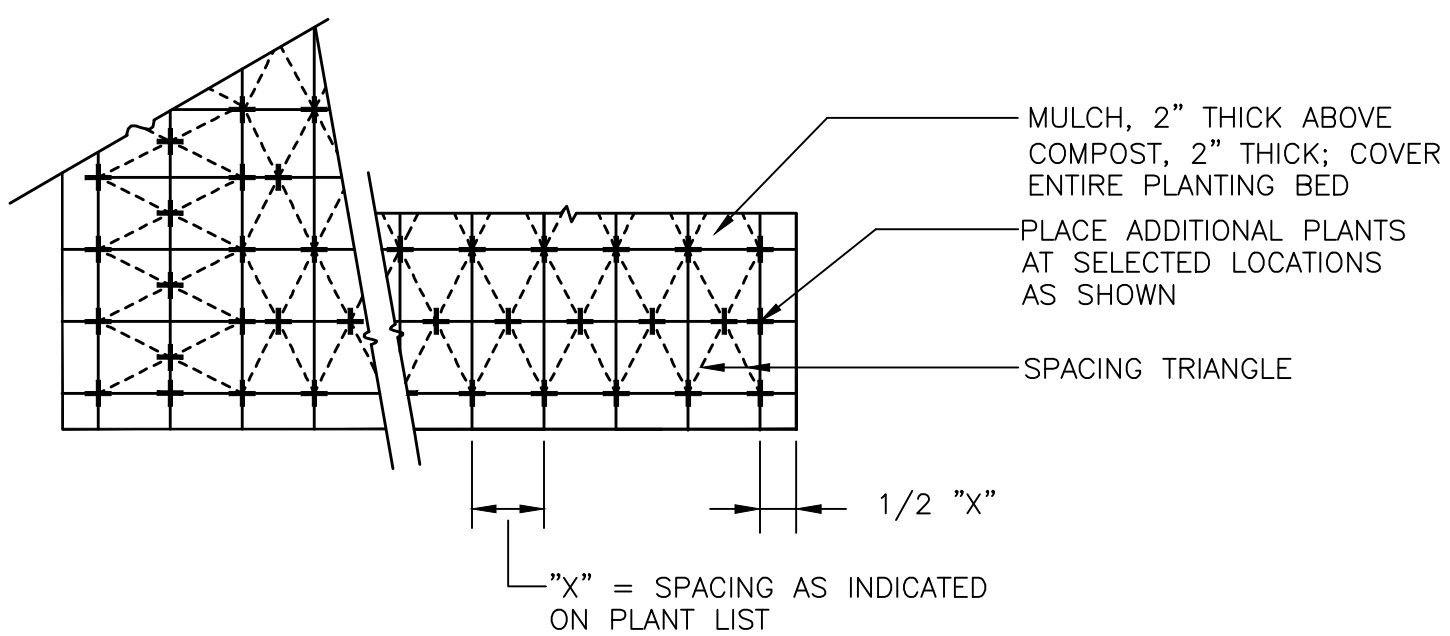


6 GROUND COVER PLANTING
L501 NOT TO SCALE

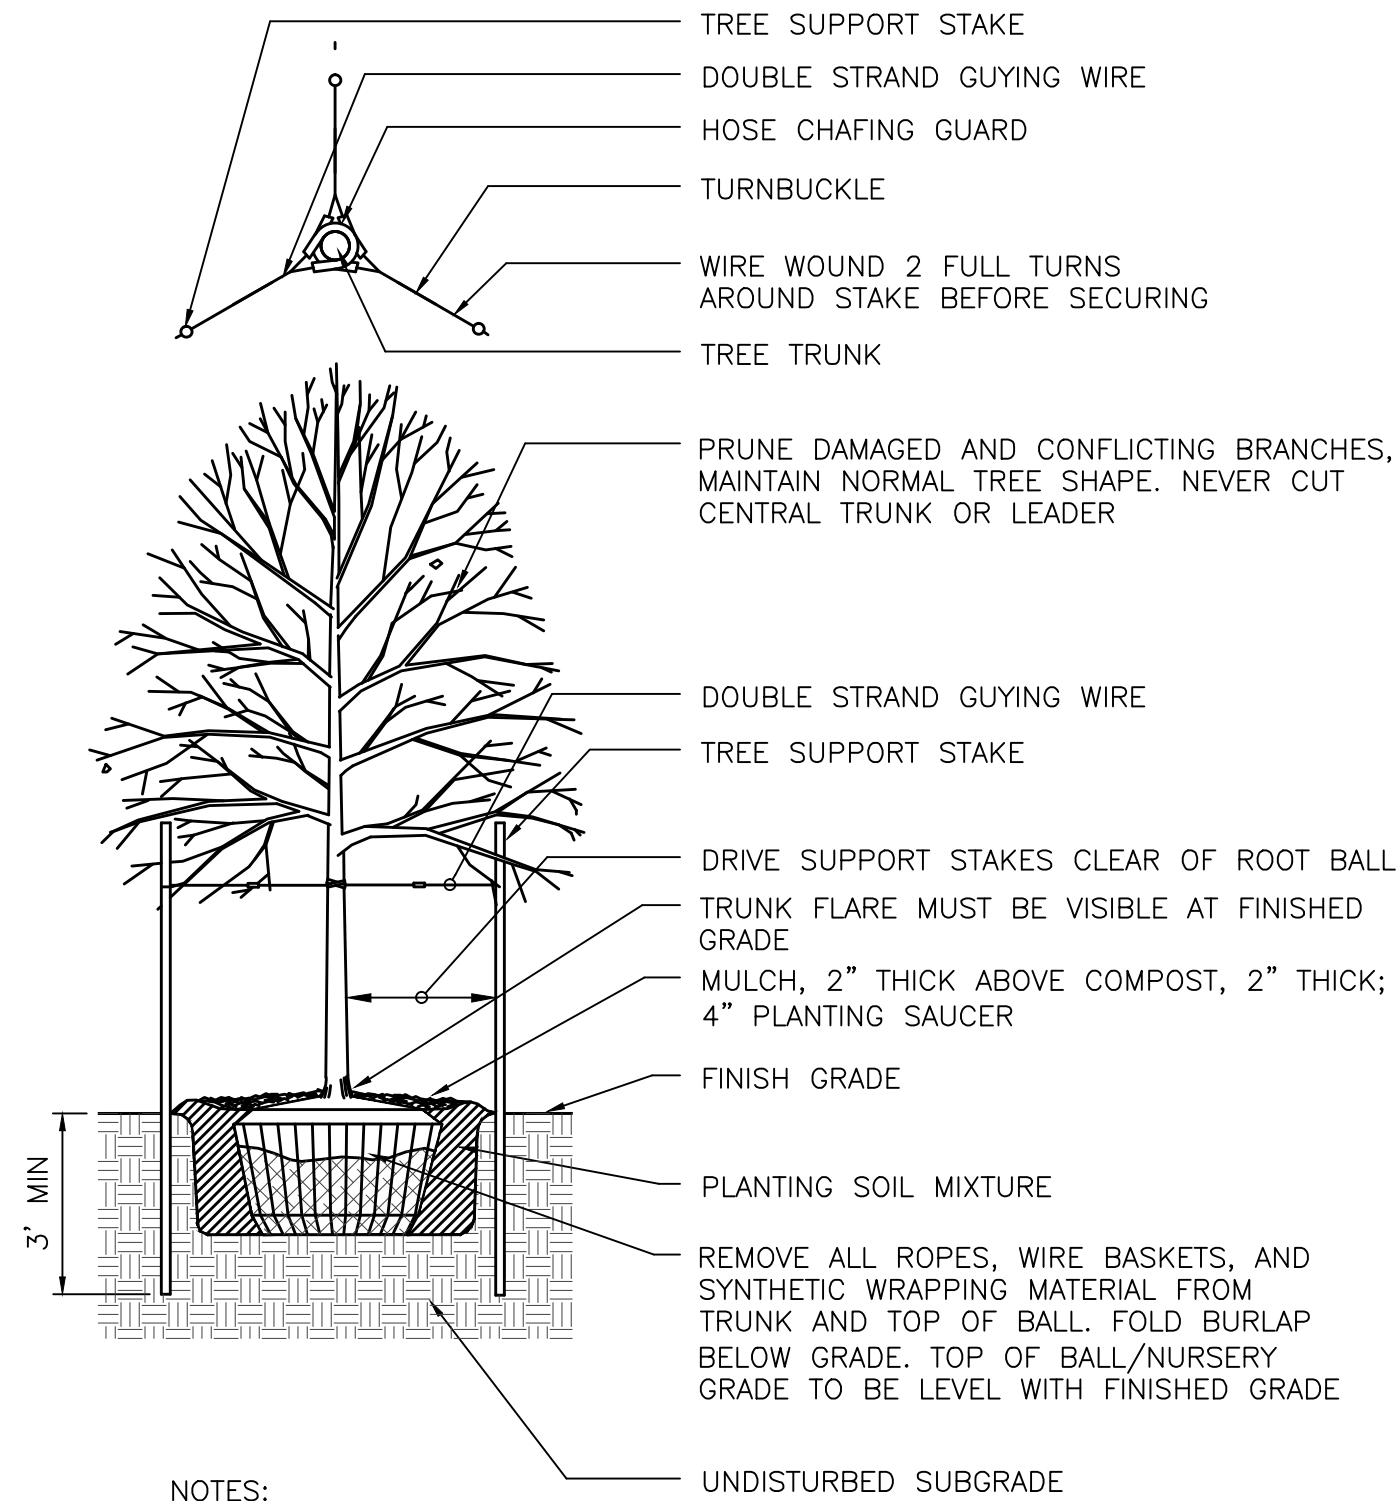


NOTES:
1. HEIGHT OF GUYING WIRES BETWEEN 1/3 AND 1/2 TREE HEIGHT

1 DECIDUOUS TREE PLANTING
L501 NOT TO SCALE

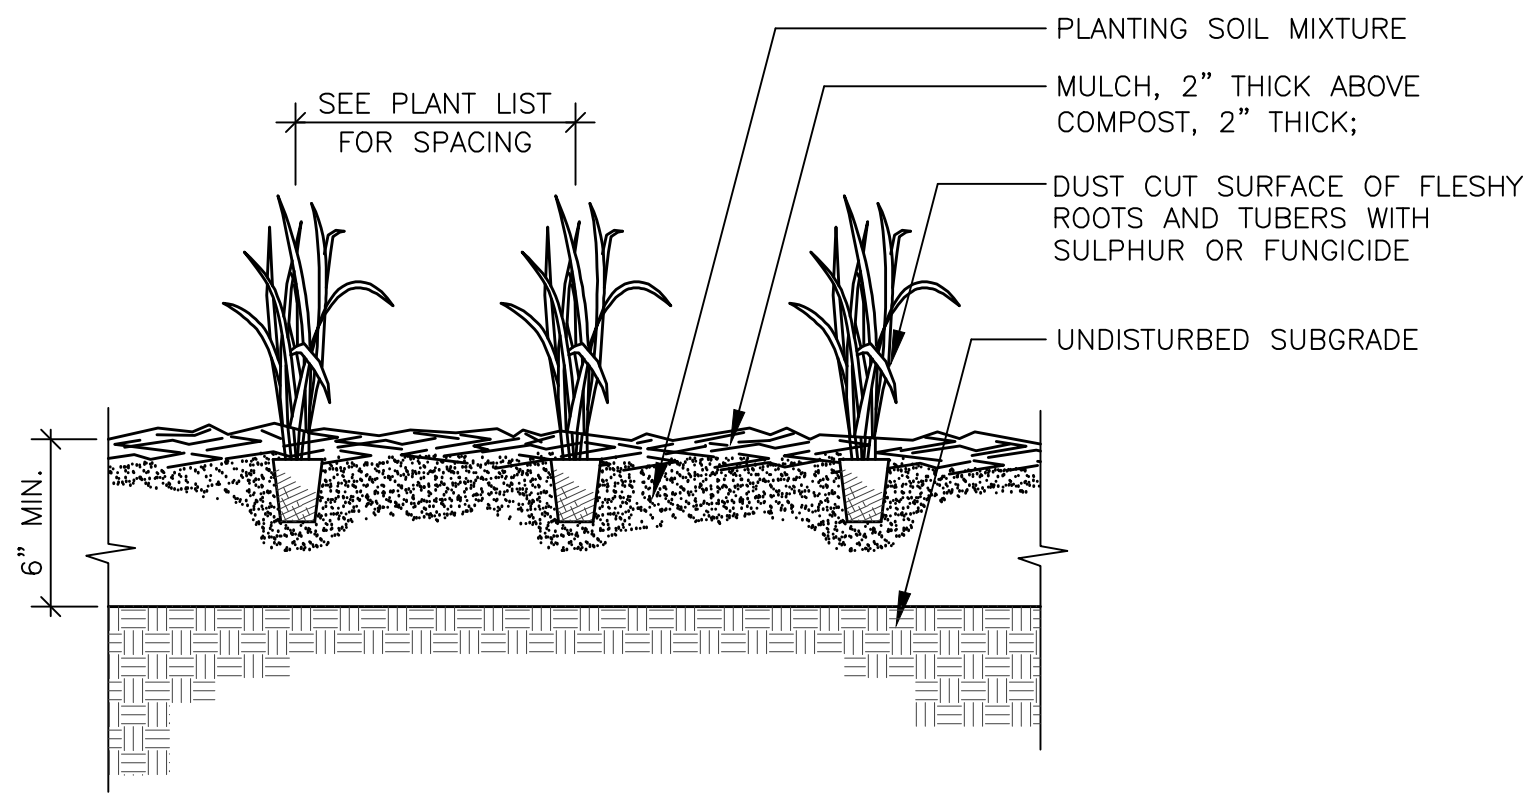

2 PERENNIAL PLANTING
L501 NOT TO SCALE

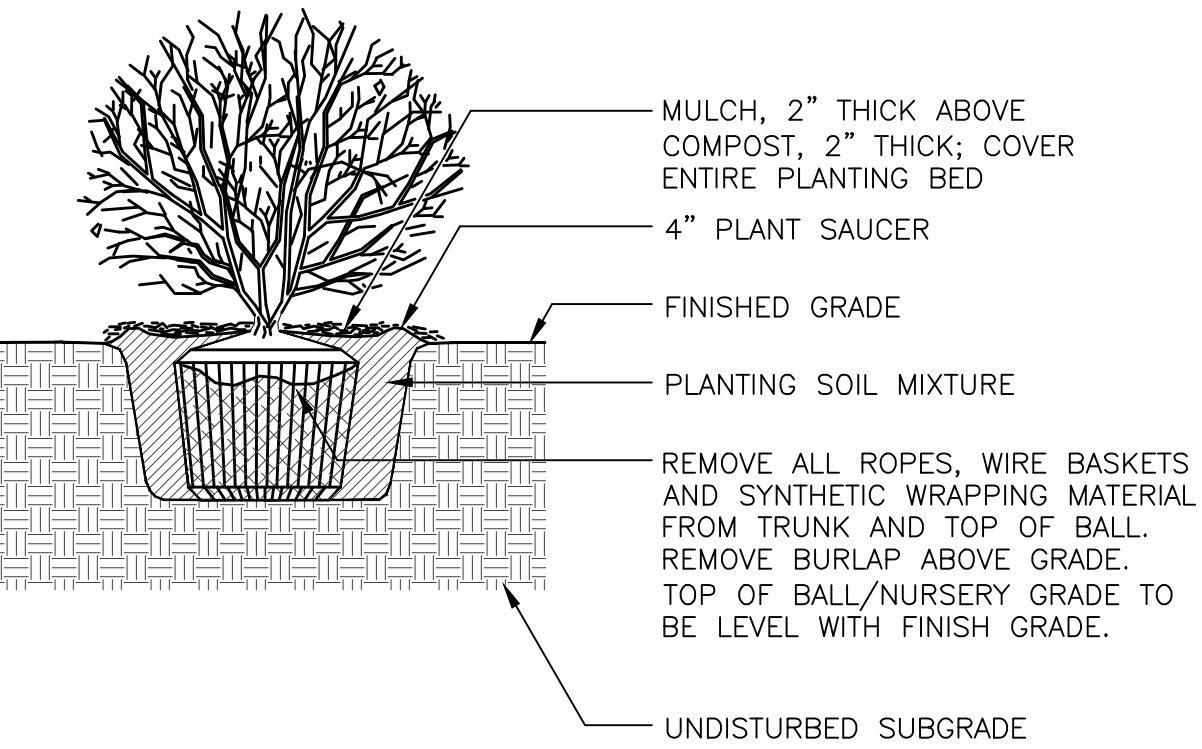

3 SHRUB PLANTING
L501 NOT TO SCALE

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FOR COMMANDER NAVFAC

ACTIVITY

SATISFACTORY TO DATE

Designer Author Checker

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BRANCH MANAGER

CHIEF ENGR ARCH

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DEPARTMENT OF THE NAVY

NAVAL FACILITIES ENGINEERING COMMAND - WASHINGTON

DDECA

MARINE CORPS BASE QUANTICO, VIRGINIA

QUANTICO, VA

REPLACE QUANTICO M/H SCHOOL

LANDSCAPE ARCHITECTURAL DETAILS

SCALE: AS NOTED

PROJECT NO.: AM000021

CONSTR. CONTR. NO.

NAVFAC DRAWING NO.

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SHEET ## OF

L501

SEAL

EWING COLE

Federal Reserve Bank Building

100 North 6th Street

Philadelphia, PA 19106

Tel: 215.923.2020 Fax: 215.574.9163

AE INFO

DATE

DESCRIPTION

SYN

APPR

ELEVATION

FOOTINGS

1-502 NOT TO SCALE

3 FOUL POLE
L-502 NOT TO SCALE

3 CONCRETE PAVING
-502 NOT TO SCALE

BOTTOM VIEW


SECTION

NOTE:

1. MODEL: 32-GALLON ALL-STEEL RECEPTACLE WITH 32-GALLON PLASTIC LINER AND SIDE DOOR.
2. FINISH/COLOR: AS SELECTED BY LANDSCAPE ARCHITECT FROM MANUFACTURER'S FULL RANGE
3. INSTALLATION METHOD: SURFACE MOUNTED, ANCHOR BOLTS SUPPLIED BY MANUFACTURER.

4 LITTER RECEPTACLE
L-502 NOT TO SCALE

1 GRANITE MONUMENT WALL
L-502 NOT TO SCALE

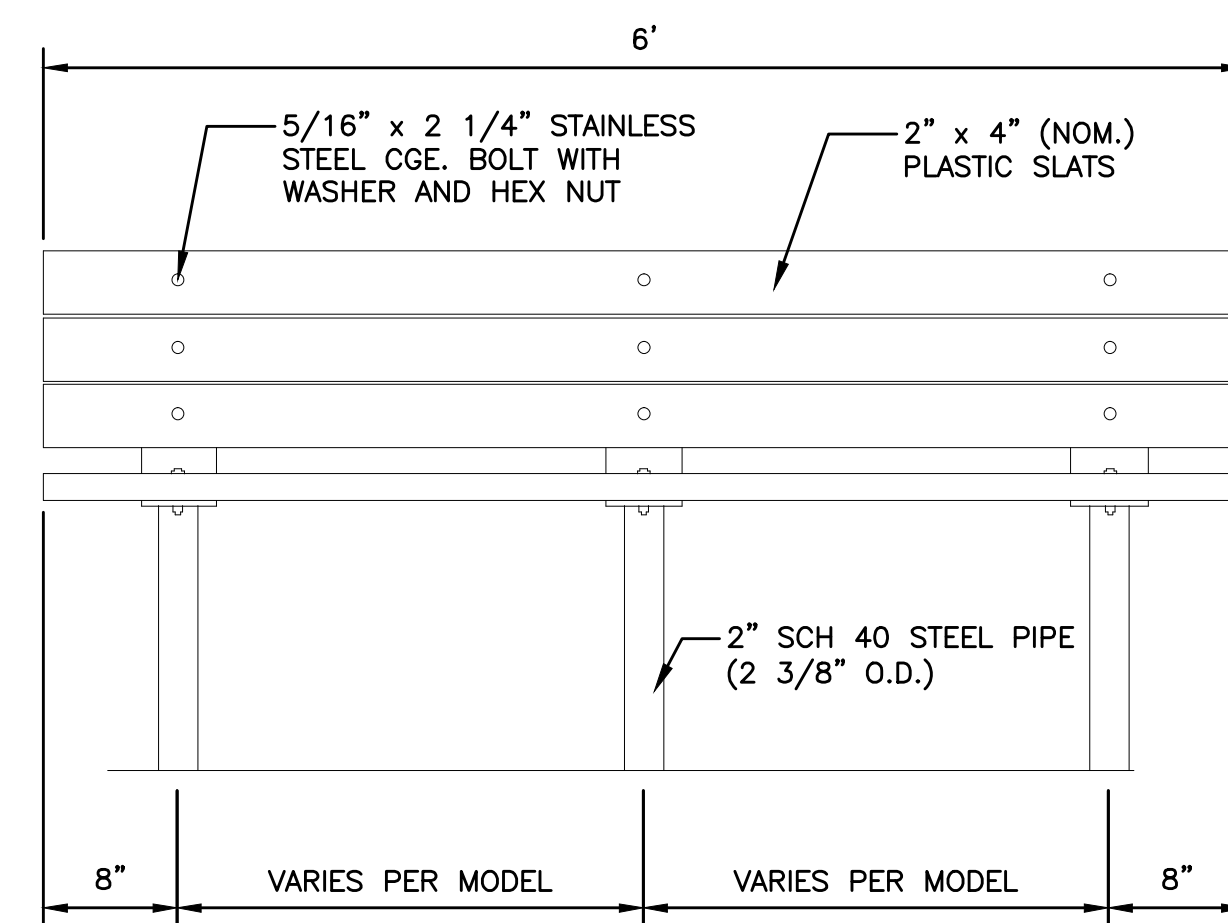

NOTE:

1. FINISH/COLOR: AS SELECTED FROM FULL RANGE BY LANDSCAPE ARCHITECT.
2. INSTALLATION METHOD: EMBEDDED.

2 RECYCLED PLASTIC BENCH
L-502 NOT TO SCALE

[illegible]

SEAL
**EWING
COLE**
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Philadelphia, PA 19106
Tel: 215.923.2020 Fax: 215.574.9163

			AVE INFO	
APPROVED				
FOR COMMANDER NAVFAC ACTIVITY				
SATISFACTORY TO			DATE	
Designer	Author		Checker	
PM/DM				
BRANCH MANAGER				
CHIEF ENG/ ARCH				
<<XXX>>				

DEPARTMENT OF THE NAVY
NAVAL FACILITIES ENGINEERING COMMAND ~ WASHINGTON
MARINE CORPS BASE QUANTICO, VIRGINIA
DODEA
MARINE CORPS BASE QUANTICO
QUANTICO, VA
REPLACE QUANTICO M/H SCHOOL
LANDSCAPE ARCHITECTURAL DETAILS

SCALE:	AS NOTED
PROJECT NO.:	AM000021
CONSTR. CONTR. NO.	
NAVFAC DRAWING NO.	#####
SHEET	## OF
L502	



C



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